

A

B

C

D

E

F

G

H

A

B

C


D

E

F

G

H

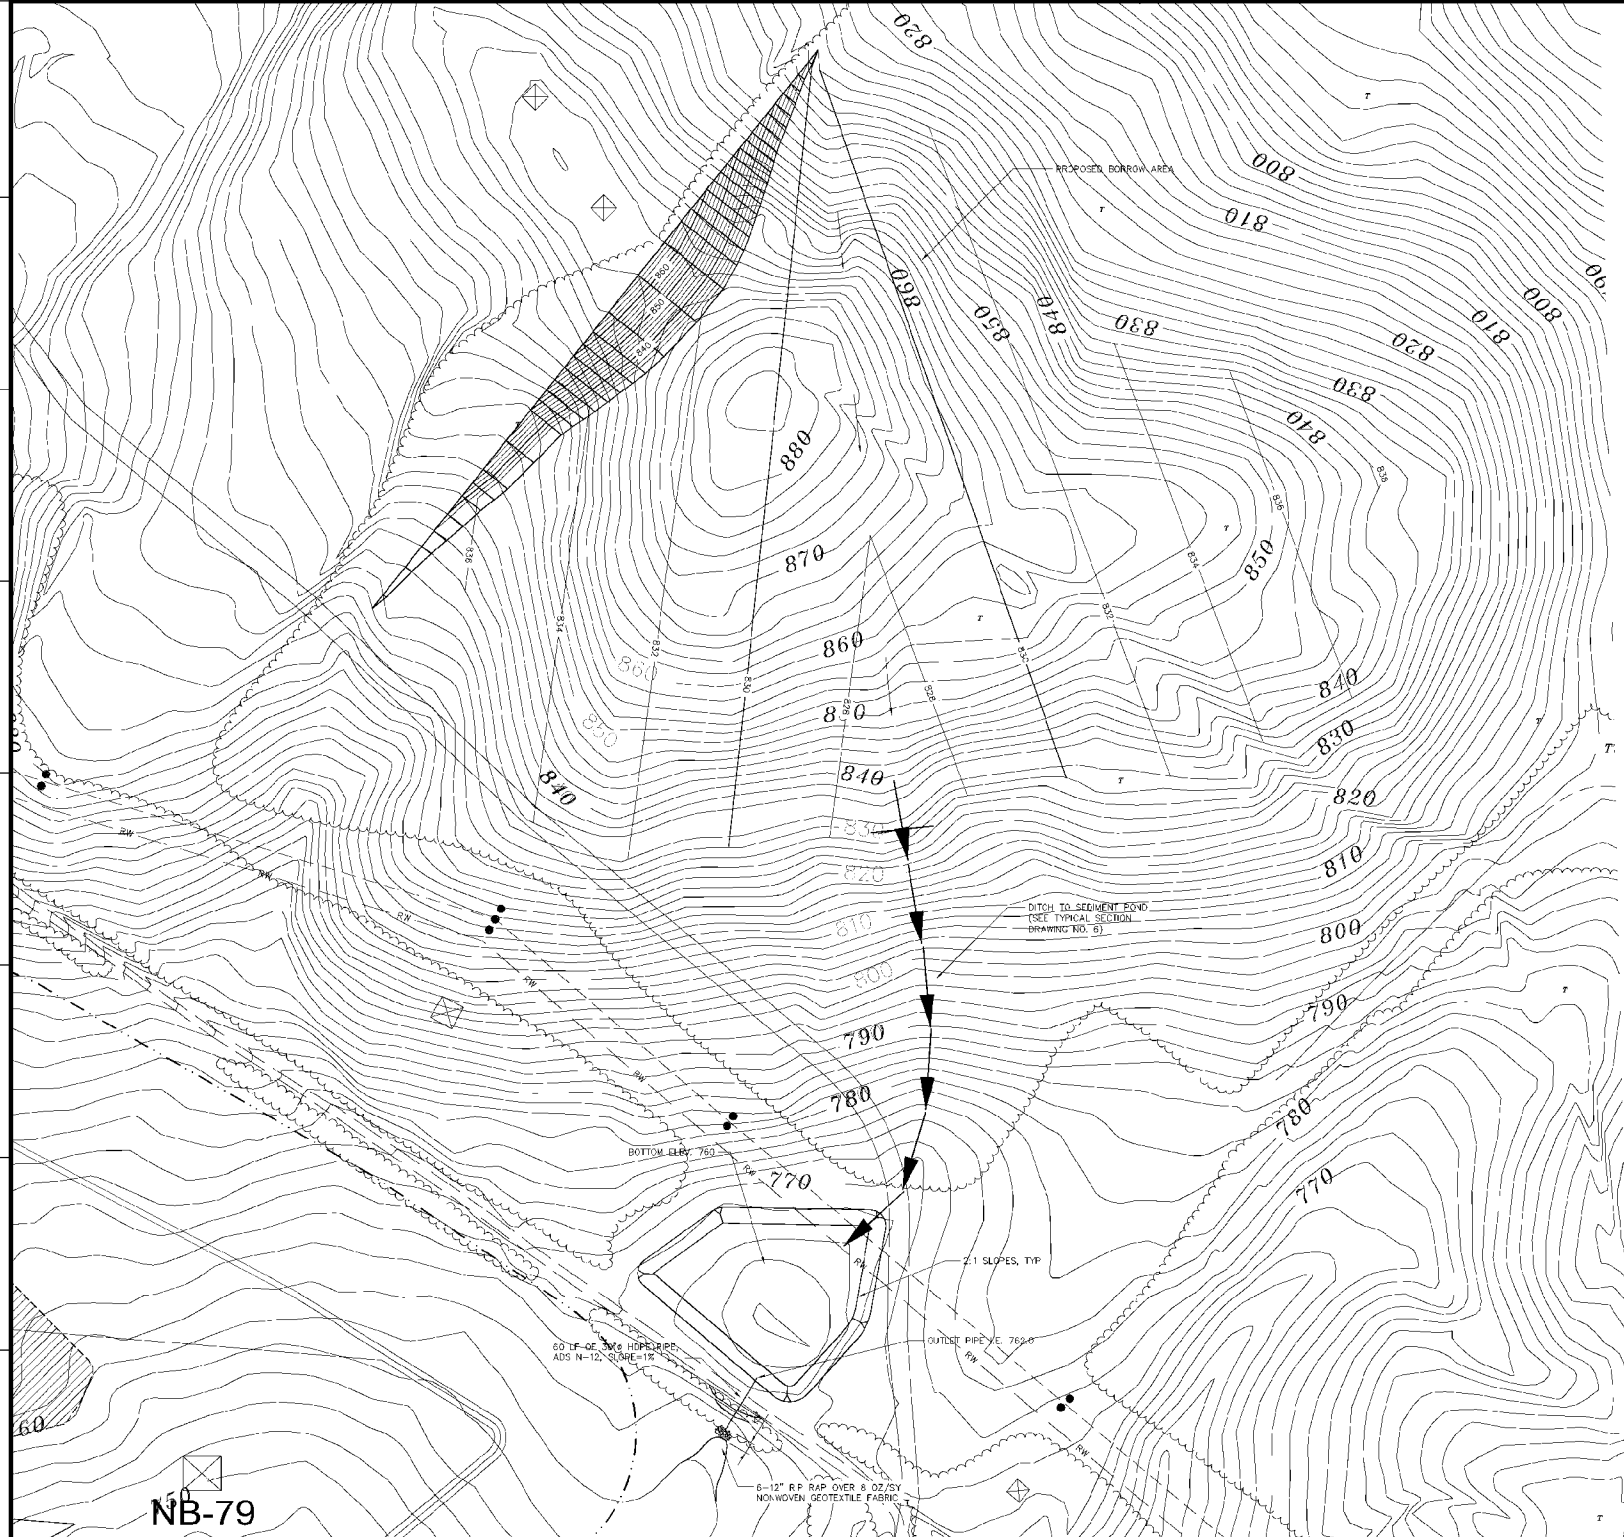

NOTE: CONTOURS MAY VARY BASED ON THE ACTUAL AMOUNT OF BORROW MATERIAL REQUIRED FOR THE PROJECT.

REV	DATE	BY	CHKD	APPD	ISSD	DISCIPLINE
01	02/08	JTS	SAH	JTS	HLP	BAK
INITIAL ISSUE FOR W.O. # KTF 00-200003-000 R0						
SCALE:	1"=60'					EXCEPT AS NOTED
YARD						
FGD GYPSUM DISPOSAL FACILITY PROPOSED BORROW AREA GRADING PLAN						
DESIGNED BY:	DRAWN BY:	CHECKED BY:	SUPERVISED BY:	REVIEWED BY:	APPROVED BY:	ISSUED BY:
J.T. STEIN	S.A. HAMBY	J.T. STEIN				
KINGSTON FOSSIL PLANT TENNESSEE VALLEY AUTHORITY FOSSIL AND HYDRO ENGINEERING						
AUTOCAD PLOT	DATE	36	C	10W428-11	R 0	

NB-79

6-12" R.P. RAP OVER 8 OZ/SY NONWOVEN GEOTEXTILE FABRIC

OUTLET PIPE 762.0

2:1 SLOPES, TYP

BOTTOM ELEV 750

DITCH TO SEDIMENT POND (SEE TYPICAL SECTION DRAWING NO. 5)

PROPOSED BORROW AREA