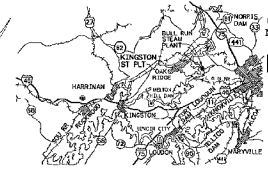
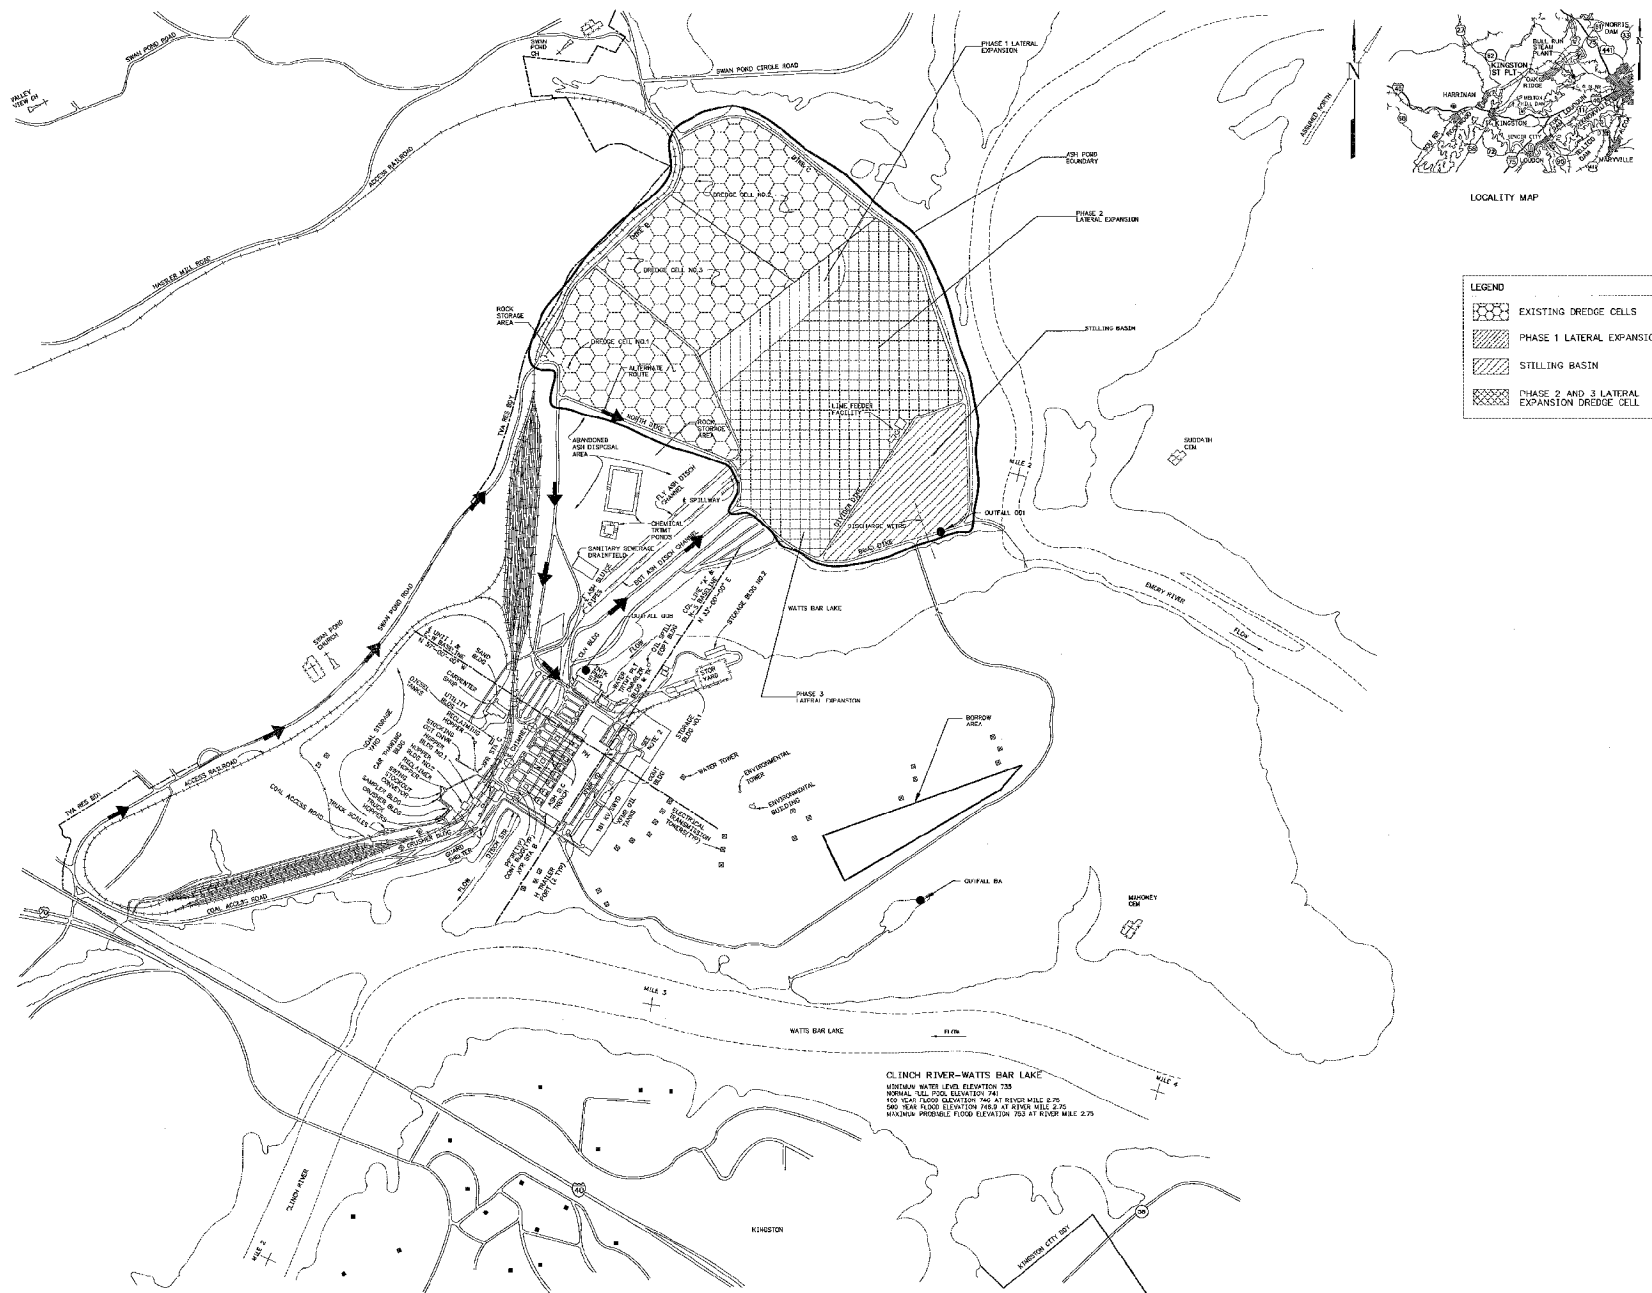


A
B
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D
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A
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LEGEND

- EXISTING DREDGE CELLS
- PHASE 1 LATERAL EXPANSION
- STILLING BASIN
- PHASE 2 AND 3 LATERAL EXPANSION DREDGE CELL

CLINCH RIVER-WATTS BAR LAKE
 USHEAN WATER LEVEL ELEVATION 735
 NORMAL TIDE POOL ELEVATION 741
 100 YEAR FLOOD ELEVATION 746.2 AT RIVER MILE 2.75
 500 YEAR FLOOD ELEVATION 746.2 AT RIVER MILE 2.75
 MAXIMUM PROBABLE FLOOD ELEVATION 753 AT RIVER MILE 2.75

TOPOGRAPHY TRACED BY M.P. TERMON 1/30/1981

SITE PLAN- KINGSTON FOSSIL PLANT

REV	DATE	BY	CHKD	APPD	DESCRIPTION
1	03/28/82	JMD	CRS	CDW	SCALE: 1" = 100'
INITIAL ISSUE TO INCORPORATE DCN K17-05-1090-004					
EXCEPT AS NOTED					
YARD					
DREDGE CELL					
LATERAL EXPANSION SITE					
LOCATION PLAN					
DESIGNED BY	DRAWN BY	CHECKED BY	APPROVED BY	DATE	SCALE
KINGSTON FOSSIL PLANT					
TENNESSEE VALLEY AUTHORITY					
FOSSIL AND HYDRO ENGINEERING					
AUTOCAD 8000	DATE	36	C	10W425-82	R D