



ATTACHMENT 1
DESIGN CONSTRUCTION DRAWINGS

HUNTERS POINT SHIPYARD SAN FRANCISCO, CALIFORNIA INSTALLATION RESTORATION SITES 7 AND 18 SOIL COVER AND SHORELINE REVETMENT DRAFT DESIGN DRAWINGS

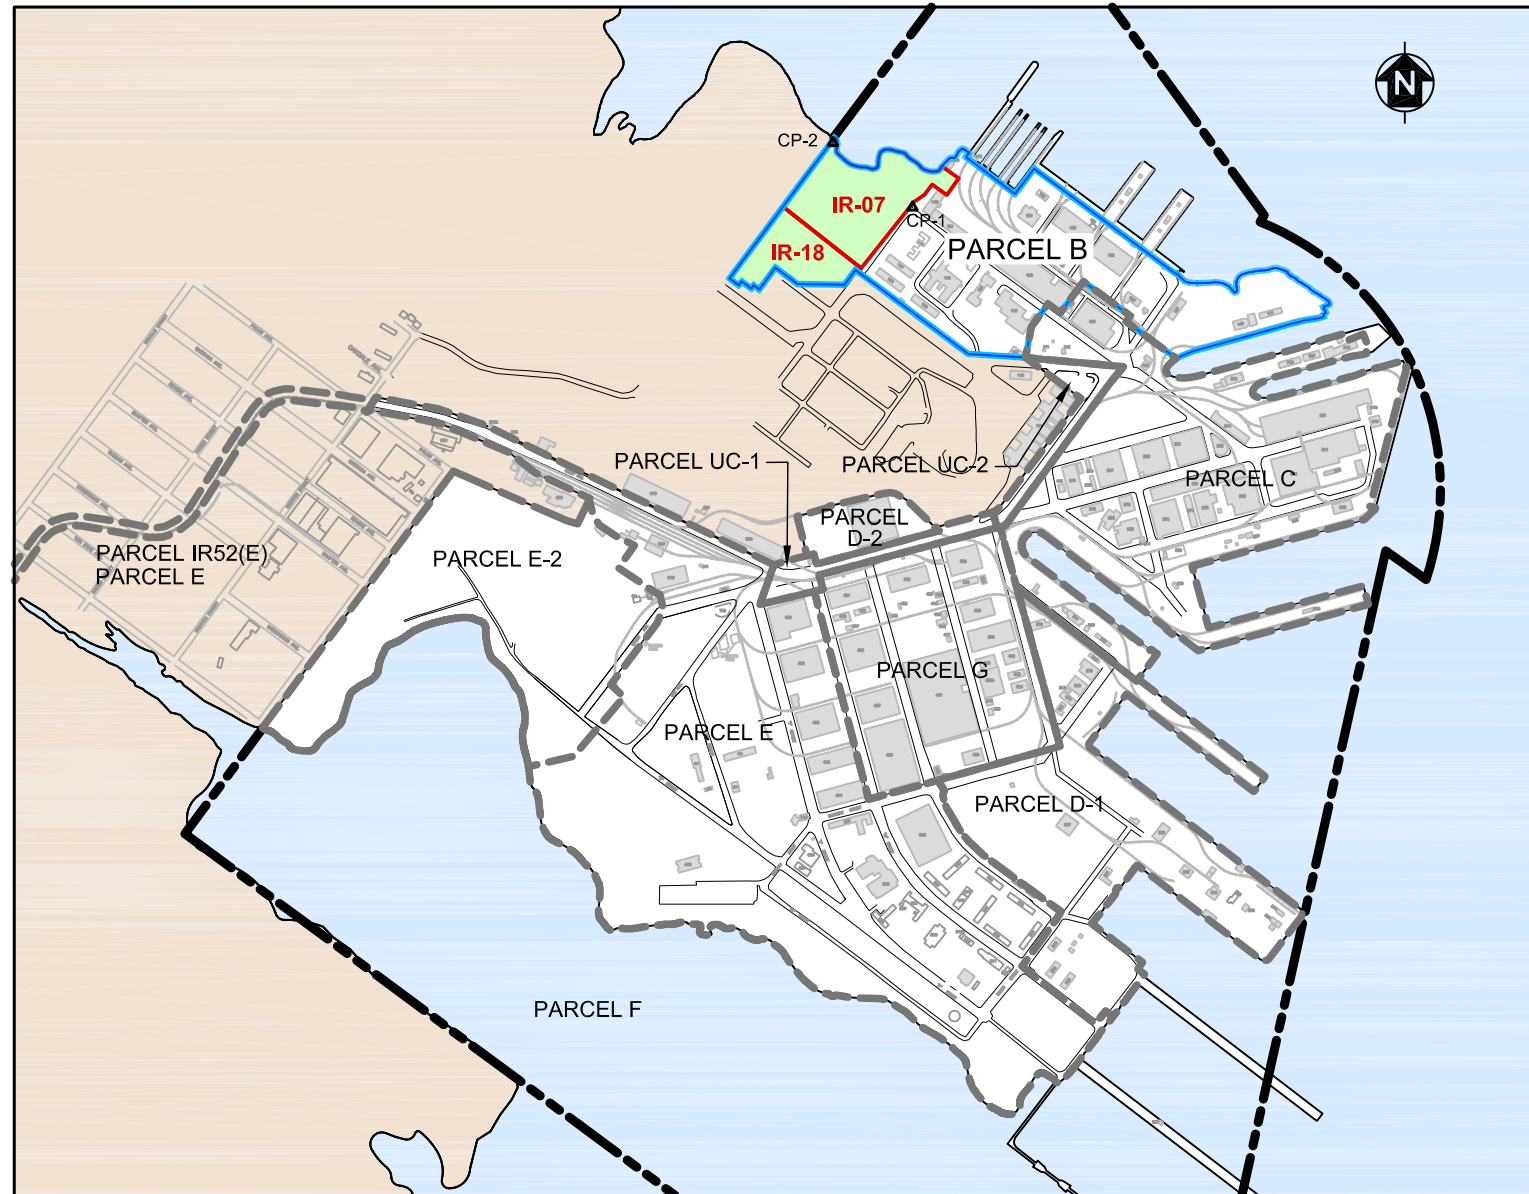

LOCATION MAP

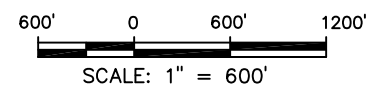

SURVEY CONTROL POINTS			
Control Point	Easting	Northing	Elevation
CP-1	1460168.99	453718.89	11.76
CP-2	1459671.50	454121.67	5.81

NOTE: OFF-SITE TOPOGRAPHY HAS BEEN SHOWN AS REFERENCED BUT HAS NOT BEEN TIED TO THE SITE TOPOGRAPHY. EXISTING TOPOGRAPHY ESTIMATED PRECISION ± 1' DUE TO MINOR REGRADING OF THE SITE FOLLOWING AS SHOWN BASELINE SURVEY.


BASIS OF BEARINGS AND ELEVATION

HORIZONTAL: NAD 1927 ZONE-III (HUNTERS POINT WEST 1 PID HT0613) USFT.

VERTICAL :
NGVD 29 LESS CORRECTION 7.76 FEET MSL

LIMITS OF RESPONSIBILITY

THE DESIGNER AND ITS SUBCONTRACTORS SHALL NOT BE RESPONSIBLE FOR VARIANCES FROM THE CONSTRUCTION SPECIFICATIONS, DESIGN DRAWINGS, AND OTHER REQUIREMENTS AND RECOMMENDATIONS UNAPPROVED BY THE DESIGNER.

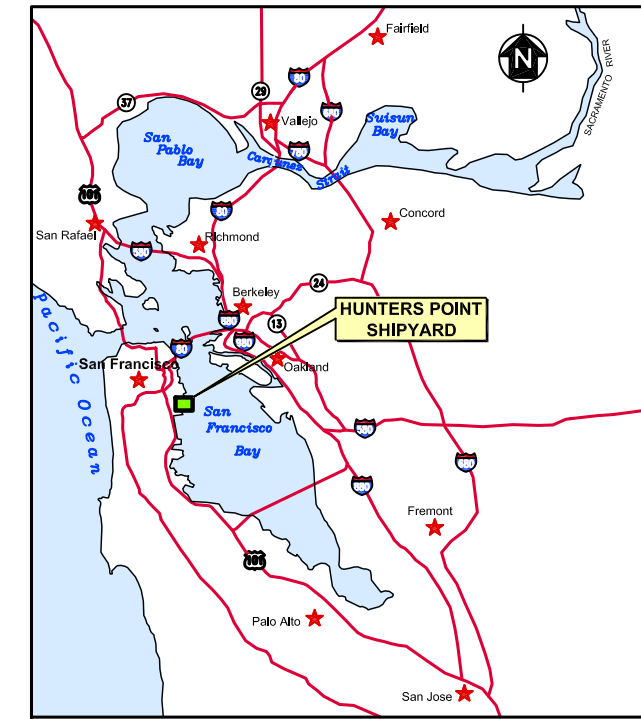

VICINITY MAP
NOT TO SCALE

INDEX OF DRAWINGS

DWG	DESCRIPTION
G1	VICINITY MAP, LOCATION MAP, AND SHEET INDEX
C1	SITE PLAN - CLEARING, GRUBBING, SURFACE DEBRIS REMOVAL AND WELL AND PROBE EXTENSIONS
C2	SOIL COVER AND REVETMENT SUBGRADE PLAN
C3	SOIL COVER AND SHORELINE REVETMENT FINAL GRADING PLAN
C4	CONTROL POINTS
C5	SHORELINE AND REVETMENT CROSS-SECTIONS A, B, AND C
C6	SHORELINE AND REVETMENT CROSS-SECTIONS D, E, AND F
C7	SHORELINE AND REVETMENT CROSS-SECTIONS G, H, I, AND J
C8	SOIL COVER BOUNDARY CROSS-SECTIONS DETAILS A, B, C, AND D
C9	SOIL COVER CROSS-SECTIONS DETAILS A-A' AND B-B'
C10	MONITORING WELL AND METHANE PROBE EXTENSION DETAILS
C11	DETAILS I
C12	DETAILS II

DETAIL DESIGNATION



SHEET WHERE DETAIL/ SECTION IS CALLED OUT

SHEET WHERE DETAIL/ SECTION IS DRAWN

NOTE: SECTION DETAILS ARE DESIGNATED BY A LETTER AND PLAN DETAILS ARE DESIGNATED BY A NUMBER.

**DRAFT
NOT FOR CONSTRUCTION**


SYMBOL	DESCRIPTION	PREP BY	DATE	APPROVED

DESIGNED BY: JBL	RE-CHECKED BY: _____
DRAWN BY: DMF	APPROVED BY: _____
CHECKED BY: SWF	DATE: 05/22/2009

SIZE D
IF SHEET IS LESS THAN 22" X 34" IT IS A REDUCED PRINT
SCALE REDUCED ACCORDINGLY

DEPARTMENT OF THE NAVY
NAVAL FACILITIES ENGINEERING COMMAND
BRAC PMO WEST
SAN DIEGO, CALIFORNIA
IR SITES 7 & 18 SOIL COVER AND SHORELINE REVETMENT
VICINITY MAP, LOCATION MAP, AND SHEET INDEX

Hunters Point Shipyard
San Francisco, California
DWG. NO.
G1
SHEET 1 OF 13

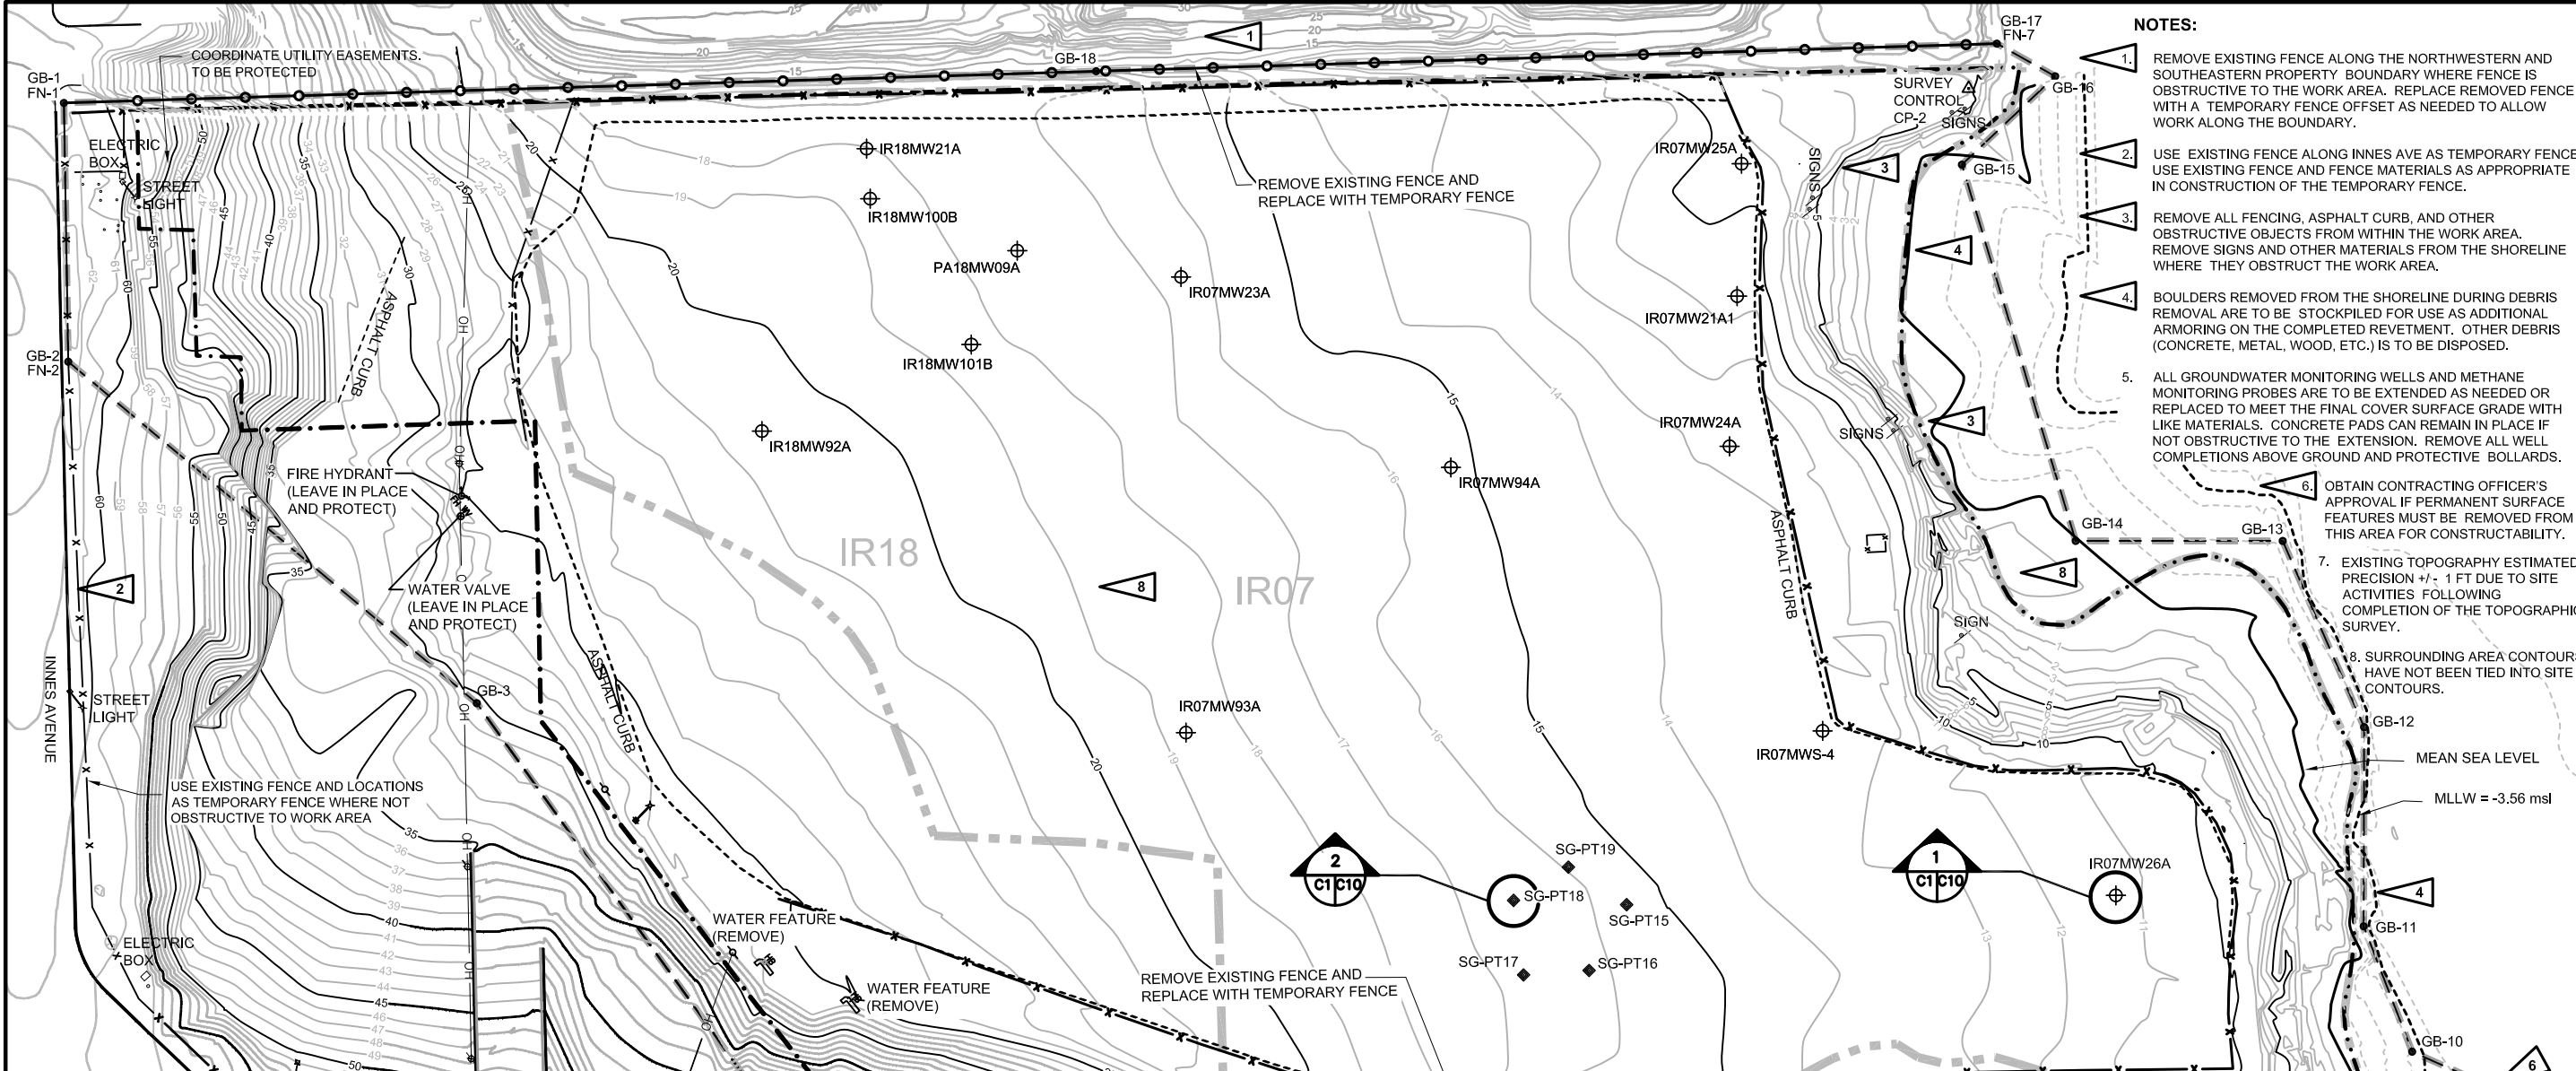

- NOTES:**
- REMOVE EXISTING FENCE ALONG THE NORTHWESTERN AND SOUTHEASTERN PROPERTY BOUNDARY WHERE FENCE IS OBSTRUCTIVE TO THE WORK AREA. REPLACE REMOVED FENCE WITH A TEMPORARY FENCE OFFSET AS NEEDED TO ALLOW WORK ALONG THE BOUNDARY.
 - USE EXISTING FENCE ALONG INNES AVE AS TEMPORARY FENCE. USE EXISTING FENCE AND FENCE MATERIALS AS APPROPRIATE IN CONSTRUCTION OF THE TEMPORARY FENCE.
 - REMOVE ALL FENCING, ASPHALT CURB, AND OTHER OBSTRUCTIVE OBJECTS FROM WITHIN THE WORK AREA. REMOVE SIGNS AND OTHER MATERIALS FROM THE SHORELINE WHERE THEY OBSTRUCT THE WORK AREA.
 - BOULDERS REMOVED FROM THE SHORELINE DURING DEBRIS REMOVAL ARE TO BE STOCKPILED FOR USE AS ADDITIONAL ARMORING ON THE COMPLETED REVETMENT. OTHER DEBRIS (CONCRETE, METAL, WOOD, ETC.) IS TO BE DISPOSED.
 - ALL GROUNDWATER MONITORING WELLS AND METHANE MONITORING PROBES ARE TO BE EXTENDED AS NEEDED OR REPLACED TO MEET THE FINAL COVER SURFACE GRADE WITH LIKE MATERIALS. CONCRETE PADS CAN REMAIN IN PLACE IF NOT OBSTRUCTIVE TO THE EXTENSION. REMOVE ALL WELL COMPLETIONS ABOVE GROUND AND PROTECTIVE BOLLARDS.
 - OBTAIN CONTRACTING OFFICER'S APPROVAL IF PERMANENT SURFACE FEATURES MUST BE REMOVED FROM THIS AREA FOR CONSTRUCTABILITY.
 - EXISTING TOPOGRAPHY ESTIMATED PRECISION +/- 1 FT DUE TO SITE ACTIVITIES FOLLOWING COMPLETION OF THE TOPOGRAPHIC SURVEY.
 - SURROUNDING AREA CONTOURS HAVE NOT BEEN TIED INTO SITE CONTOURS.

EXISTING GROUNDWATER MONITORING WELLS AND METHANE MONITORING PROBES EXTENSION SCHEDULE

Well ID	Easting	Northing	Well Depth (ft. bgs)	Casing Dia. (in.)	Stick-Up Construction
IR07MW20A1	1460379.24	453944.26	24.00	4	NO
IR07MW21A1	1459683.70	453941.51	16.50	4	NO
IR07MW23A	1459476.14	453693.82	17.00	4	NO
IR07MW24A	1459749.67	453884.37	15.00	4	YES
IR07MW25A	1459624.70	453990.88	18.00	4	YES
IR07MW26A	1460093.30	453900.68	15.00	4	YES
IR07MW93A	1459686.30	453533.20	29.00	2	NO
IR07MW94A	1459659.70	453749.30	25.00	2	NO
IR07MWS-2	1460286.15	453860.98	15.50	4	YES
IR07MWS-4	1459913.20	453825.23	16.00	4	YES
IR07P20A	1460374.65	453927.21	25.00	2	NO
IR18MW100B	1459329.10	453579.54	47.00	4	NO
IR18MW101B	1459432.00	453573.70	45.00	4	NO
IR18MW21A	1459304.90	453595.74	20.00	4	NO
IR18MW92A	1459396.70	453446.90	27.00	2	NO
PA18MW09A	1459405.47	453628.25	25.00	4	NO
SG-PT15	1459922.63	453673.40	3.00	TUBE	NO
SG-PT16	1459939.27	453632.67	3.00	TUBE	NO
SG-PT17	1459917.88	453601.10	3.00	TUBE	NO
SG-PT18	1459880.20	453623.16	3.00	TUBE	NO
SG-PT19	1459884.61	453660.16	3.00	TUBE	NO

CLEARING AND GRUBBING CONTROL POINTS

Point ID	Easting	Northing
GB-1	1458996.94	453244.69
GB-2	1459116.91	453154.18
GB-3	1459419.24	453219.12
GB-4	1459764.15	453204.97
GB-5	1460273.78	453857.25
GB-6	1460376.47	453777.02
GB-7	1460484.04	453914.71
GB-8	1460366.54	454006.50
GB-9	1460335.57	454014.91
GB-10	1460270.80	453980.39
GB-11	1460196.05	454003.03
GB-12	1460105.13	454074.42
GB-13	1459990.79	454103.70
GB-14	1459916.77	454008.96
GB-15	1459703.93	454091.38
GB-16	1459696.86	454165.85
GB-17	1459661.06	454150.64
GB-18	1459351.58	453728.48

TEMPORARY FENCE CONTROL POINTS

Point ID	Easting	Northing
FN-1	1458996.94	453244.69
FN-2	1459116.91	453154.18
FN-3	1459741.53	453227.66
FN-4	1459825.05	453320.55
FN-5	1459843.31	453306.28
FN-6	1460208.68	453773.94
FN-7	1459661.06	454150.64

LEGEND

- IR SITE 7 BOUNDARY
- IR SITE 18 BOUNDARY
- EXTENT OF RESTRICTIONS RELATED TO RADIONUCLIDES
- EXISTING MAJOR CONTOUR (5 FT.)
- EXISTING MINOR CONTOUR (1 FT.)
- ASPHALT CURB (REMOVE)
- OVERHEAD POWER LINE (PROTECT DURING CONSTRUCTION)
- EXISTING FENCE
- EXISTING FENCE (REMOVE)
- TEMPORARY FENCE (TO BE INSTALLED DURING CONSTRUCTION)
- APPROXIMATE LIMITS OF CLEARING AND GRUBBING AND DEBRIS REMOVAL
- SURVEY CONTROL POINT
- UTILITY FEATURE
- UTILITY POLE (REMOVE)
- UTILITY POLE (LEAVE IN PLACE)
- WATER FEATURE
- MONITORING WELL (PROTECT AND EXTEND)
- METHANE MONITORING PROBE (PROTECT AND EXTEND)
- GRUBBING BOUNDARY CONTROL POINT
- TEMPORARY FENCE CONTROL POINT

SURVEY CONTROL DATUM
 HORIZONTAL (BASIS OF BEARINGS):
 NAD27 ZONE-III (HUNTERS POINT WEST 1 PID HT0613) USFT.
 VERTICAL (BENCH MARK):
 NGVD 29 LESS CORRECTION 7.76 FEET MSL

Scale: 1" = 50'

DRAFT NOT FOR CONSTRUCTION

CHADTUT JV
 CONSULTING ENGINEERS

DESIGNED BY: JBL
 DRAWN BY: DMF
 CHECKED BY: []

RE-CHECKED BY: []
 APPROVED BY: []
 DATE: 05/22/2009

PREP BY: []
 DATE: []
 APPROVED: []

REVISIONS

SYMBOL DESCRIPTION

SIZE D
 IF SHEET IS LESS THAN 22" X 34" IT IS A REDUCED PRINT
 SCALE REDUCED ACCORDINGLY


DEPARTMENT OF THE NAVY
 BRAC PMO WEST
 SAN DIEGO, CALIFORNIA

NAVAL FACILITIES ENGINEERING COMMAND

IR SITES 7 & 18 SOIL COVER AND SHORELINE REVETMENT SITE PLAN - CLEARING, GRUBBING, SURFACE DEBRIS REMOVAL AND WELL AND PROBE EXTENSIONS

Hunters Point Shipyard
 San Francisco, California

DWG. NO. **C1**
 SHEET 2 OF 13

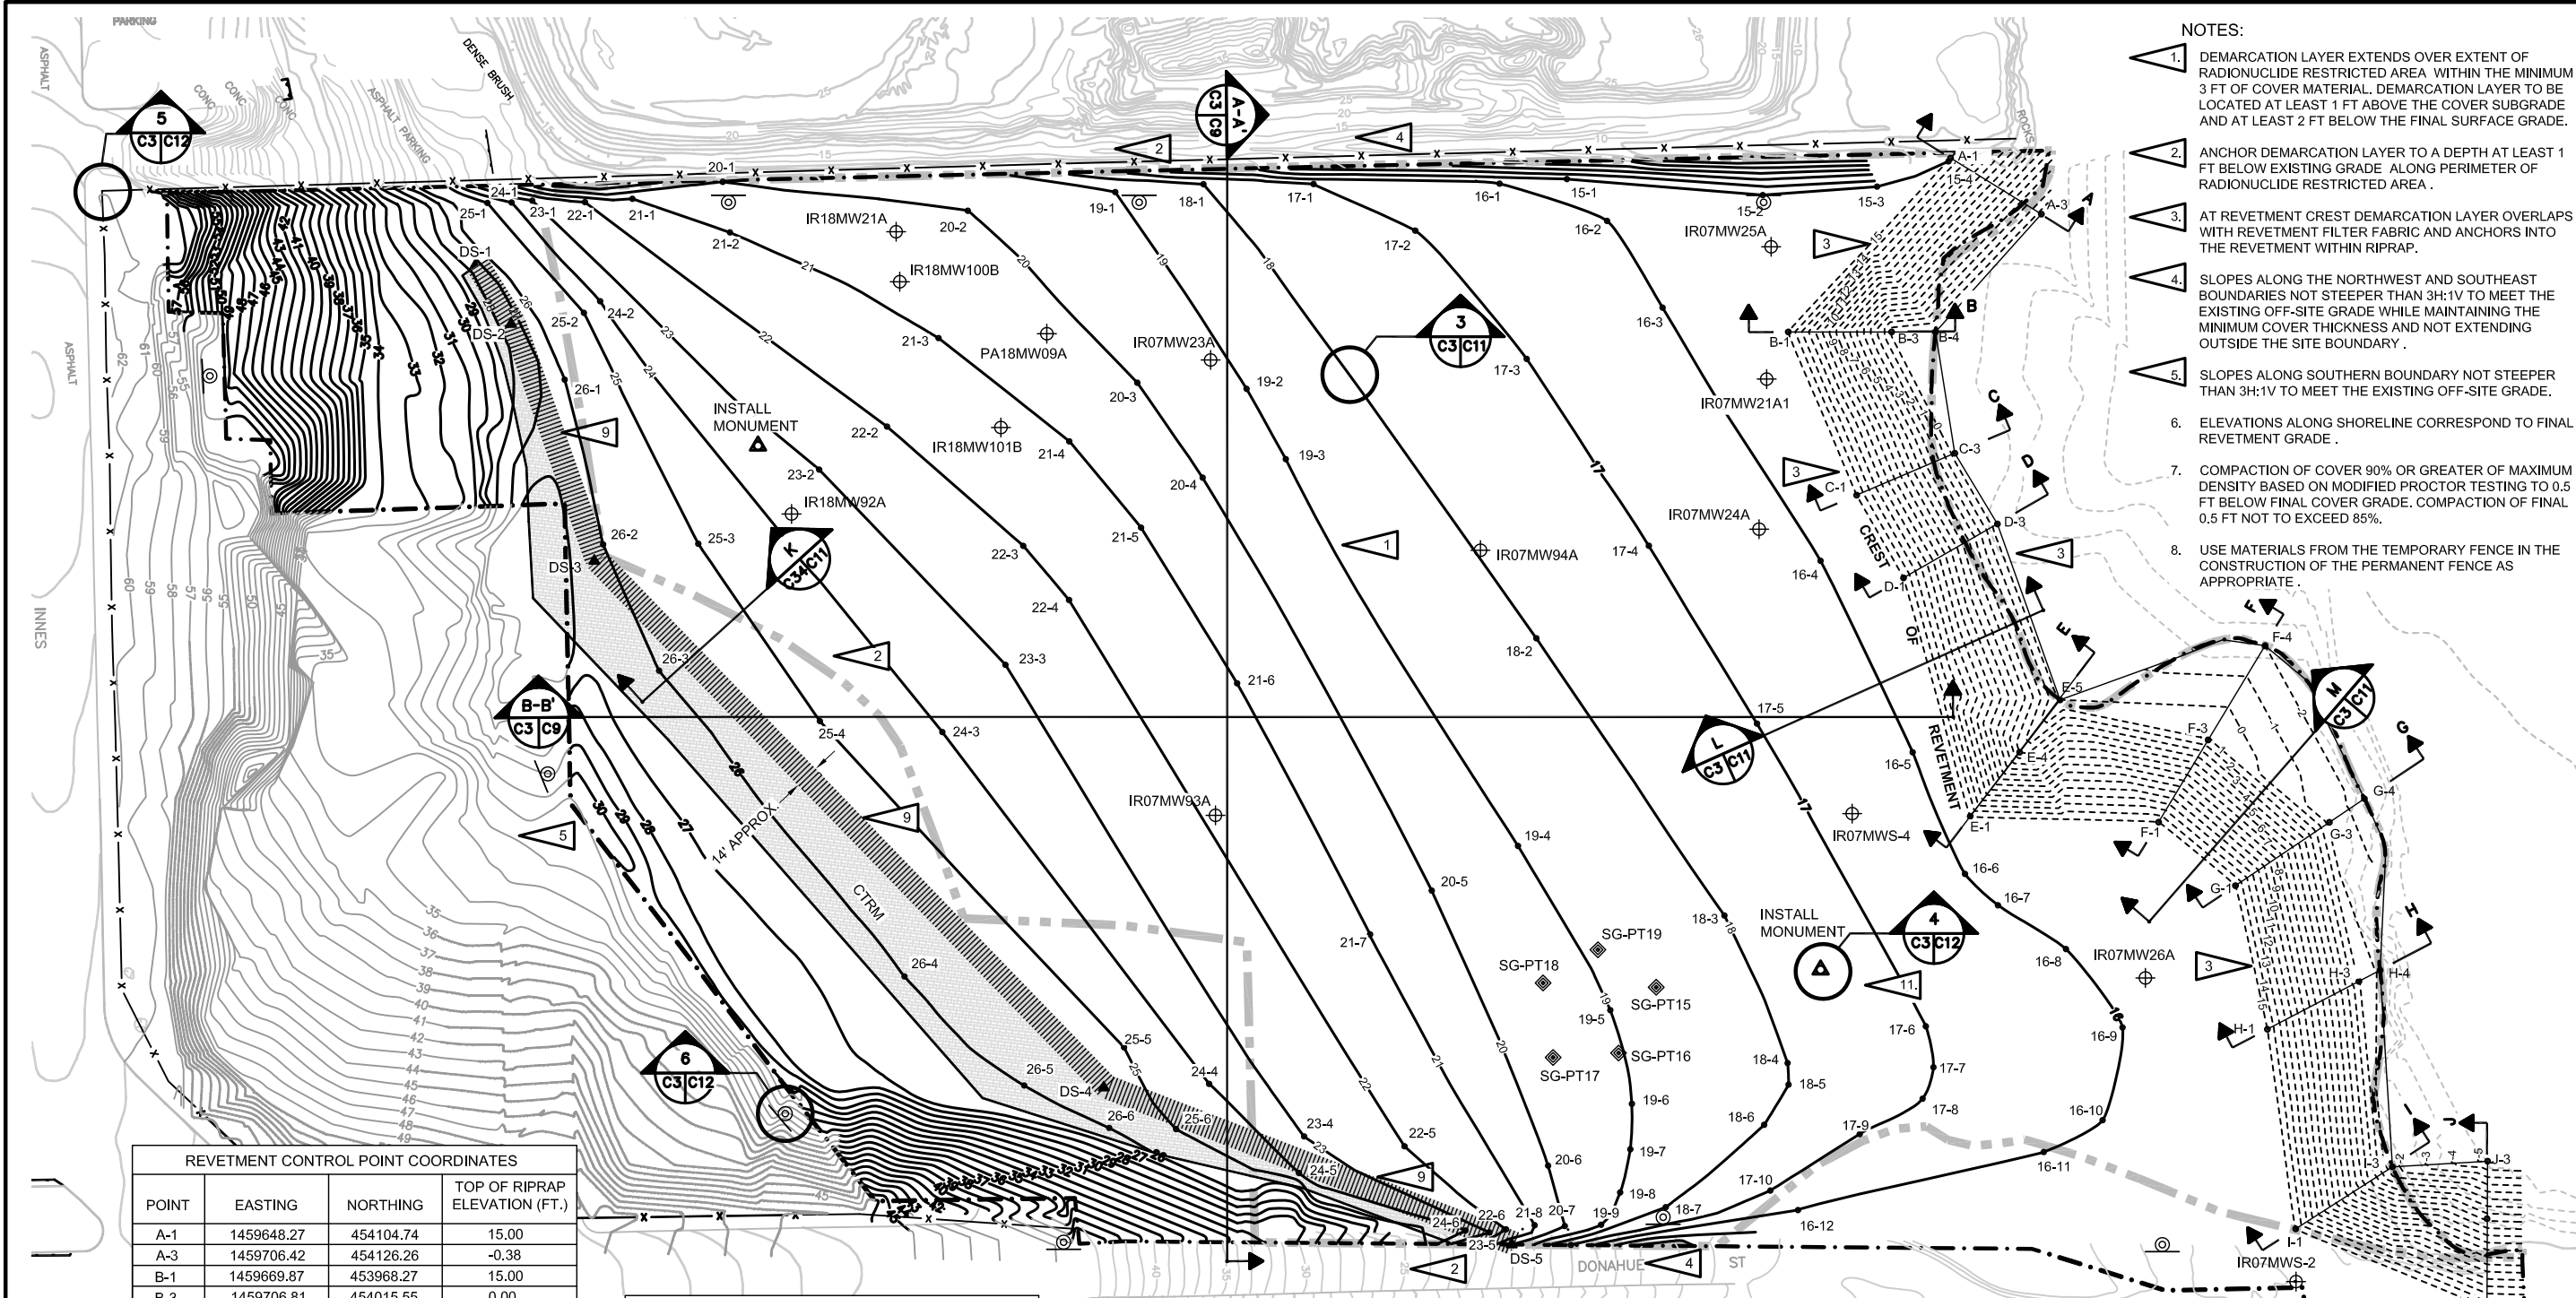

- NOTES:**
1. DEMARCATION LAYER EXTENDS OVER EXTENT OF RADIONUCLIDE RESTRICTED AREA WITHIN THE MINIMUM 3 FT OF COVER MATERIAL. DEMARCATION LAYER TO BE LOCATED AT LEAST 1 FT ABOVE THE COVER SUBGRADE AND AT LEAST 2 FT BELOW THE FINAL SURFACE GRADE.
 2. ANCHOR DEMARCATION LAYER TO A DEPTH AT LEAST 1 FT BELOW EXISTING GRADE ALONG PERIMETER OF RADIONUCLIDE RESTRICTED AREA.
 3. AT REVETMENT CREST DEMARCATION LAYER OVERLAPS WITH REVETMENT FILTER FABRIC AND ANCHORS INTO THE REVETMENT WITHIN RIPRAP.
 4. SLOPES ALONG THE NORTHWEST AND SOUTHEAST BOUNDARIES NOT STEEPER THAN 3H:1V TO MEET THE EXISTING OFF-SITE GRADE WHILE MAINTAINING THE MINIMUM COVER THICKNESS AND NOT EXTENDING OUTSIDE THE SITE BOUNDARY.
 5. SLOPES ALONG SOUTHERN BOUNDARY NOT STEEPER THAN 3H:1V TO MEET THE EXISTING OFF-SITE GRADE.
 6. ELEVATIONS ALONG SHORELINE CORRESPOND TO FINAL REVETMENT GRADE.
 7. COMPACTION OF COVER 90% OR GREATER OF MAXIMUM DENSITY BASED ON MODIFIED PROCTOR TESTING TO 0.5 FT BELOW FINAL COVER GRADE. COMPACTION OF FINAL 0.5 FT NOT TO EXCEED 85%.
 8. USE MATERIALS FROM THE TEMPORARY FENCE IN THE CONSTRUCTION OF THE PERMANENT FENCE AS APPROPRIATE.

REVETMENT CONTROL POINT COORDINATES

POINT	EASTING	NORTHING	TOP OF RIPRAP ELEVATION (FT.)
A-1	1459648.27	454104.74	15.00
A-3	1459706.42	454126.26	-0.38
B-1	1459669.87	453968.27	15.00
B-3	1459706.81	454015.55	0.00
B-4	1459722.49	454035.63	-0.92
C-1	1459769.00	453941.19	15.00
C-3	1459784.90	454001.11	-0.40
D-1	1459823.63	453933.06	12.00
D-3	1459832.53	453995.31	-0.71
E-1	1459956.62	453878.33	15.00
E-4	1459944.99	453923.84	2.23
E-5	1459935.47	453961.05	0.00
F-1	1460026.69	453962.45	15.00
F-3	1460006.79	454014.55	1.02
F-4	1459983.97	454074.31	-2.27
G-1	1460083.25	453974.91	15.00
G-3	1460087.85	454040.56	-1.46
G-4	1460087.85	454065.03	-2.43
H-1	1460160.41	453938.16	15.00
H-3	1460171.19	453997.18	0.00
H-4	1460173.69	454010.87	-1.19
I-1	1460261.91	453879.72	15.00
I-3	1460268.13	453946.18	-1.65
J-1	1460366.54	453939.02	15.00
J-3	1460299.59	453991.73	-5.04

DRAINAGE SWALE CONTROL POINT COORDINATES

POINT	EASTING	NORTHING	ELEVATION FT.
DS-1	1459169.98	453390.68	27.40
DS-2	1459209.43	453386.50	27.43
DS-3	1459347.70	453339.84	26.00
DS-4	1459771.01	453384.65	25.51
DS-5	1459988.70	453515.24	20.00

REVETMENT CROSS SECTION LOCATION


CROSS SECTION	SHEET	CROSS SECTION	SHEET
A	C-5	F	C-6
B	C-5	G	C-7
C	C-5	H	C-7
D	C-6	I	C-7
E	C-6	J	C-7

- NOTES (cont.)**
9. DRAINAGE SWALE SLOPES 3H:1V ON SIDE FACING UPGRADIENT AND 10H:1V ON SIDE FACING DOWNGRADIENT. PLACE COMPOSITE TURF REINFORCED MATTING (CTRM) ALONG WATERCOURSE TO ELEVATION 1 FT ABOVE WATER COURSE.
 10. REFER TO C5 THROUGH C7 FOR SHORELINE CROSS SECTIONS.
 11. SURVEY AND RECORD MONUMENT LOCATIONS AND ELEVATIONS (TYP) AFTER PLACEMENT.

LEGEND


- EXTENT OF COVER BOUNDARY
- EXTENT OF RESTRICTIONS RELATED TO RADIONUCLIDES
- EXISTING CONTOUR
- PROPOSED FINAL COVER CONTOUR
- PROPOSED REVETMENT CONTOUR
- x- PERMANENT FENCE
- COMPOSITE TURF REINFORCED MATTING (CTRM)
- A-1 • REVETMENT CONTROL POINT
- 22-5 • FINAL COVER CONTROL POINT (SEE SHEET C4 FOR COORDINATES)
- ⊕ MONITORING WELL
- ◆ METHANE MONITORING PROBE
- ||||| DRAINAGE SWALE
- ⊙ SIGN
- ▲ SURVEY MONUMENT
- DS-1▲ DRAINAGE CONTROL POINT

SURVEY CONTROL DATUM
 HORIZONTAL (BASIS OF BEARINGS):
 NAD27 ZONE-III (HUNTERS POINT WEST 1 PID HT0813) USFT.
 VERTICAL (BENCH MARK):
 NGVD 29 LESS CORRECTION 7.76 FEET MSL

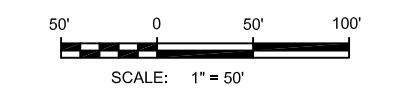


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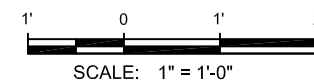
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NO.	DESCRIPTION	DATE	APPROVED						

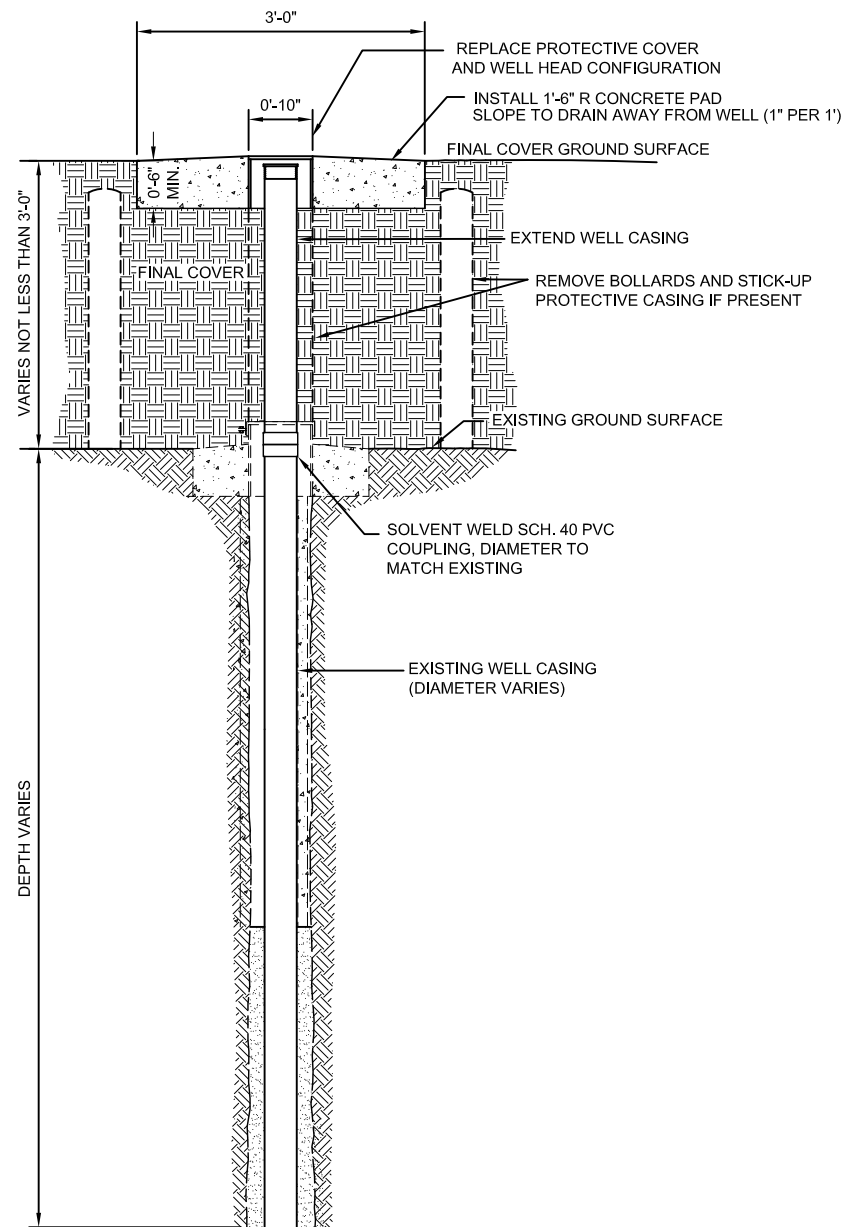

1
C1 C10
 FLUSH MOUNTED MONITORING WELL EXTENTION (TYP.)
 FOR ALL WELLS IRXXMWXX
 SCALE: 1" = 1'-0"

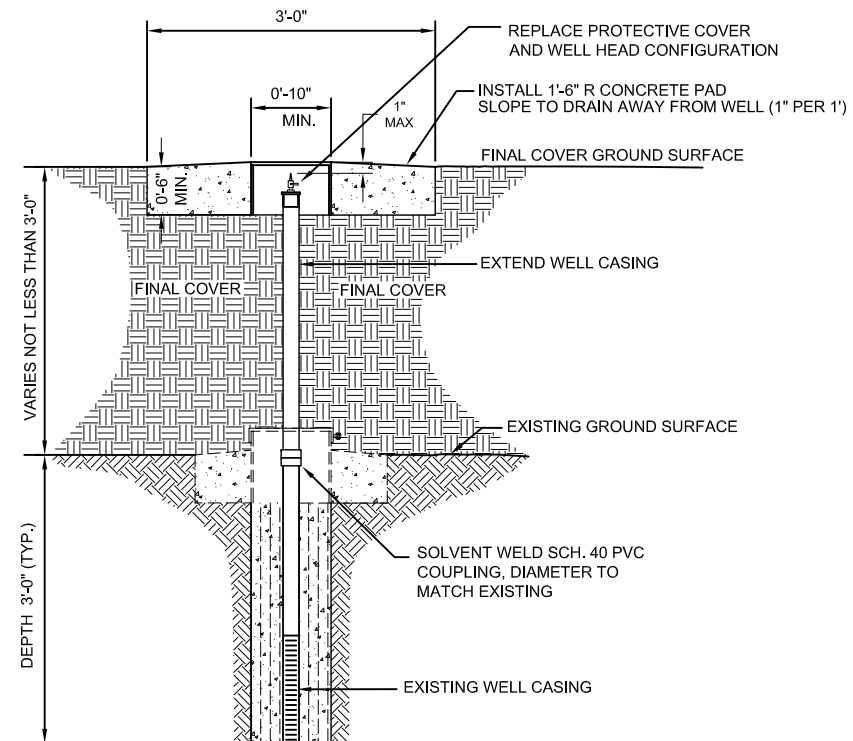


2
C1 C10
 FLUSH MOUNTED METHANE PROBE EXTENTION (TYP.)
 FOR ALL PROBES SG-XX
 SCALE: 1" = 1'-0"




- NOTE:
1. PROTECT GROUNDWATER MONITORING WELLS AND METHANE MONITORING PROBES AS NECESSARY DURING CONSTRUCTION OF THE COVER.
 2. REMOVE CONCRETE PADS AND/OR FLUSH MOUNTED PROTECTIVE CASING IF OBSTRUCTIVE TO THE EXTENSION COUPLING.

DRAFT
NOT FOR CONSTRUCTION


PREPARED BY:	DESIGNED BY: JBL	RE-CHECKED BY:	APPROVED BY:	DATE: 05/22/2009
CHADLUTT JV <small>Consulting Engineers & Scientists</small>	DRAWN BY: DMF	CHECKED BY: SWF		
SIZE D IF SHEET IS LESS THAN 22" X 34" IT IS A REDUCED PRINT SCALE REDUCED ACCORDINGLY				
DEPARTMENT OF THE NAVY BRAC PMO WEST <small>SAN DIEGO, CALIFORNIA</small> IR SITES 7 & 18 SOIL COVER AND SHORELINE REVETMENT MONITORING WELL AND METHANE MONITORING PROBE EXTENSION DETAILS				
Hunters Point Shipyard San Francisco, California				
DWG. NO. C10 SHEET 11 OF 13				
REVISIONS				

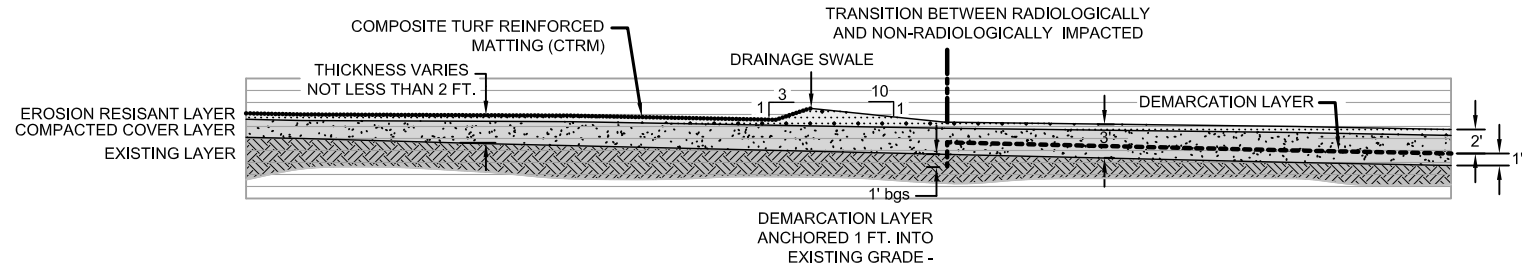

K
C3 | C11
DRAINAGE SWALE / CHANNEL
SCALE: 1" = 8'

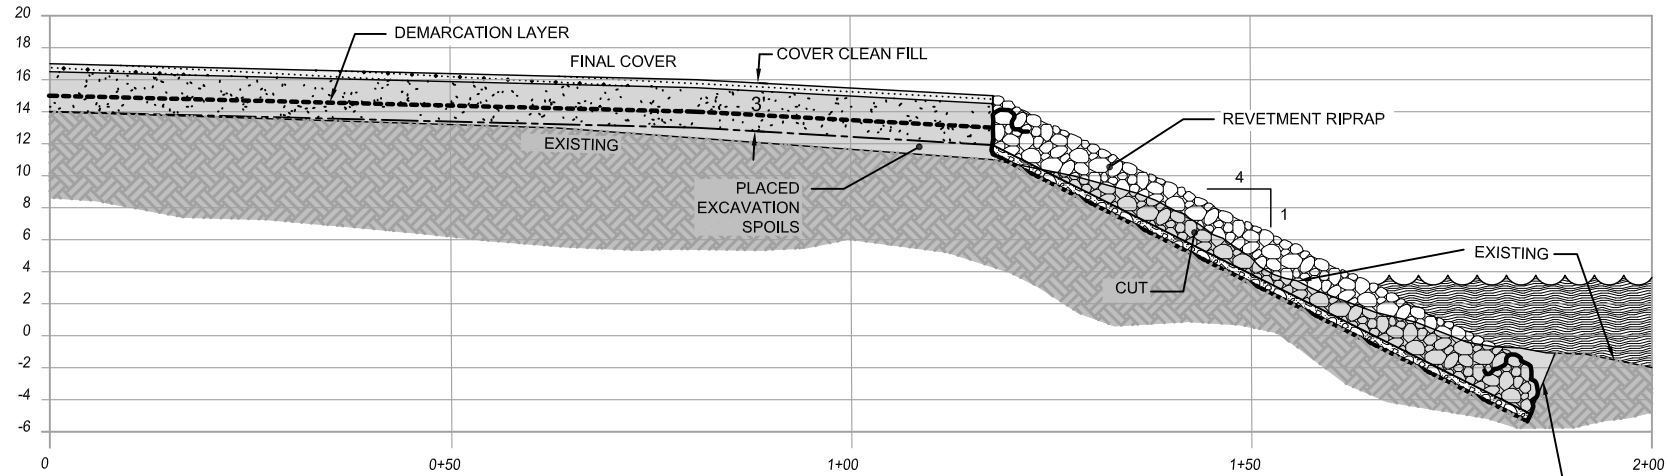


L
C3 | C11
NEAR SHORE CROSS SECTION
NOT TO SCALE
2X VERTICAL EXAGGERATION

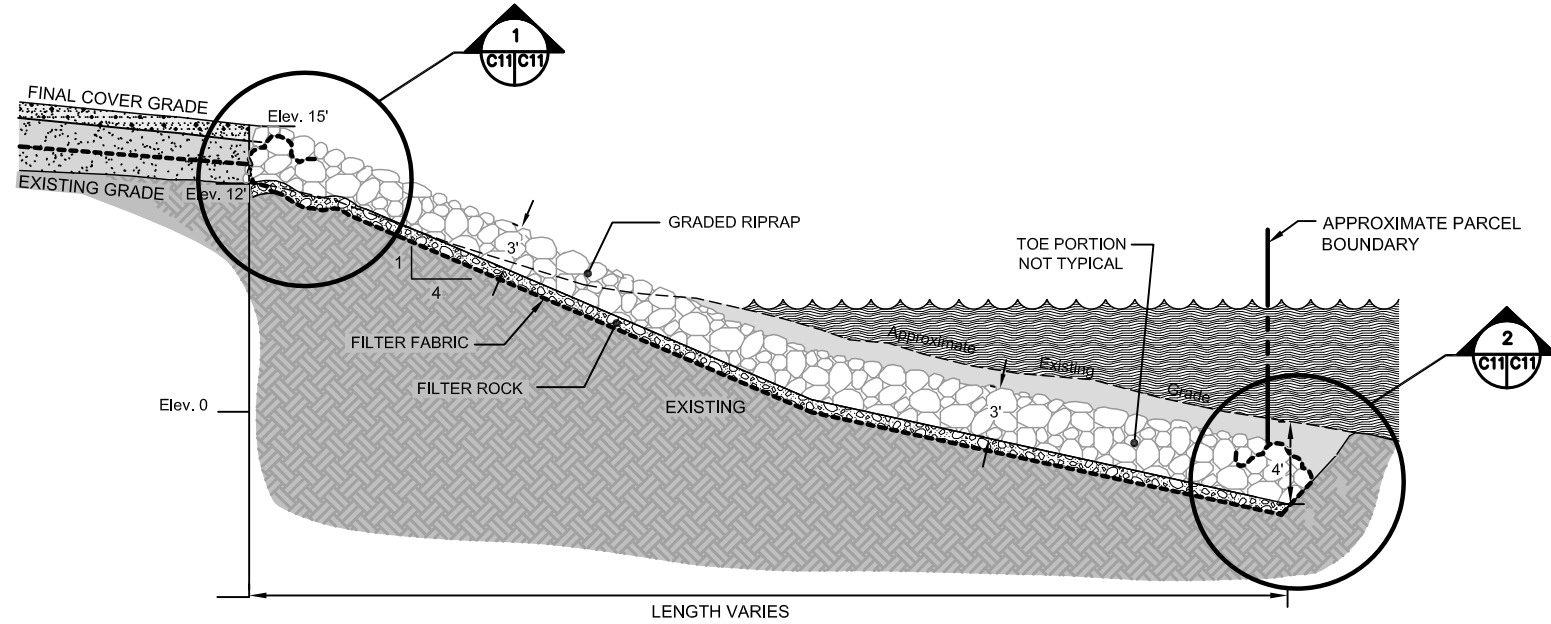


M
C3 | C11
GENERALIZED REVETMENT CROSS SECTION
NOT TO SCALE

NOTE:
ELEVATIONS ARE IN FEET ABOVE MEAN SEA LEVEL.

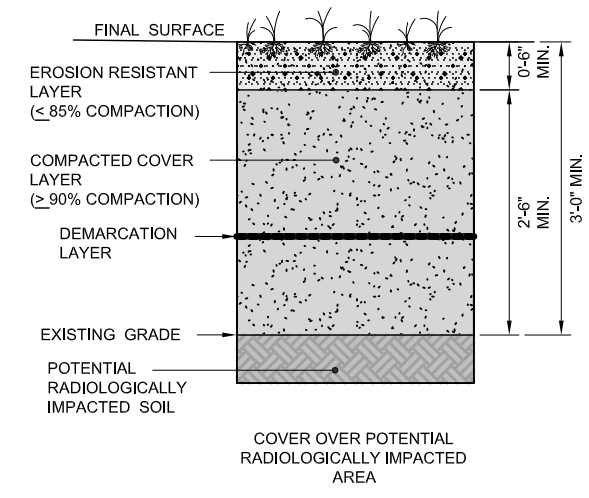


3
C3 | C11
COVER COMPONENTS
SCALE: 1" = 1'-0"

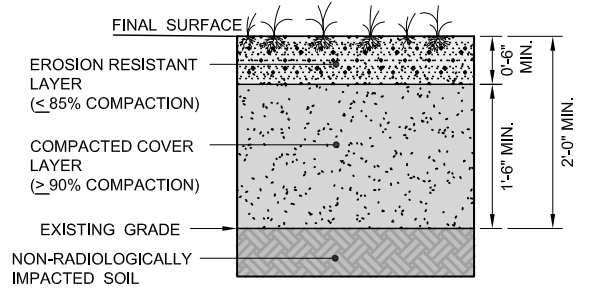


3
C3 | C11
COVER COMPONENTS
SCALE: 1" = 1'-0"

NOTE:
EXCAVATED NON RADIOLOGICALLY IMPACTED SOIL TO BE PLACED UNDER COMPACTED COVER LAYER.

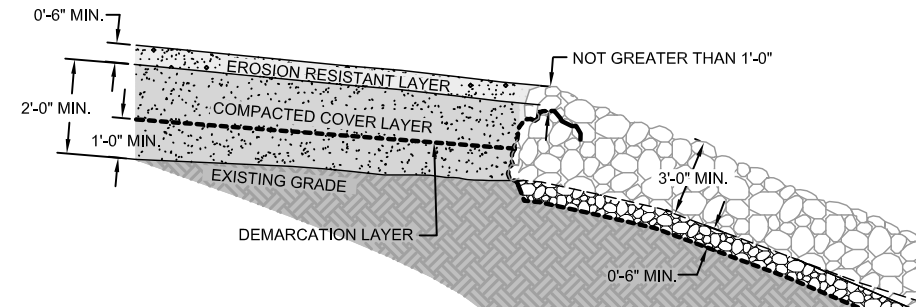


1
C11 | C11
TIE IN OF FILTER FABRIC AT CREST
SCALE: 1" = 3'-0"

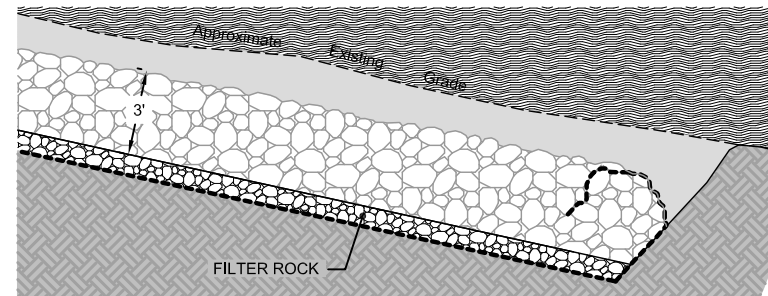

2
C11 | C11
TIE IN OF FILTER FABRIC AT TOE
SCALE: 1" = 3'-0"

**DRAFT
NOT FOR CONSTRUCTION**

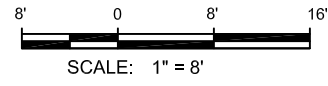

NO.	DESCRIPTION	DATE	APPROVED

DESIGNED BY: JBL	RE-CHECKED BY: _____
DRAWN BY: DMF	APPROVED BY: _____
CHECKED BY: SWF	DATE: 05/22/2009

SIZE D
IF SHEET IS LESS THAN 22" X 34" IT IS A REDUCED PRINT
SCALE REDUCED ACCORDINGLY

DEPARTMENT OF THE NAVY
NAVAL FACILITIES ENGINEERING COMMAND
BRAC PMO WEST
SAN DIEGO, CALIFORNIA
IR SITES 7 & 18 SOIL COVER AND SHORELINE REVETMENT DETAILS I

Hunters Point Shipyard
San Francisco, California

R:\Newy\Hunters-P\Parcel B\107_108\108\Preliminary Design\C11 Details.dwg 05/22/2009 deborah.tord DN

