
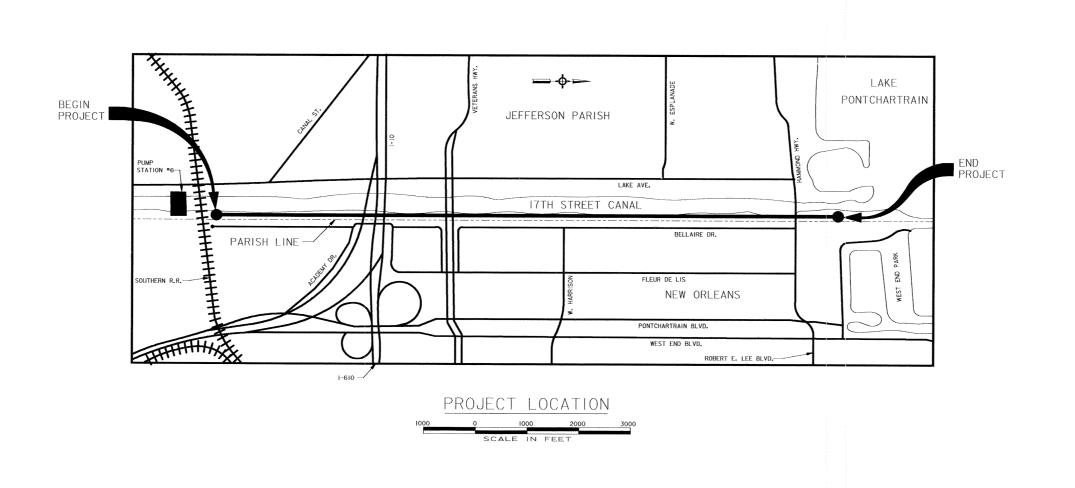


U.S. ARMY ENGINEER DISTRICT CORPS OF ENGINEERS NEW ORLEANS, LOUISIANA

EXCAVATION AND FLOOD PROTECTION - 17TH STREET CANAL CAPPING OF FLOODWALLS EAST SIDE LEVEE IMPROVEMENTS

| | INDEX |
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| DWG. NO. | DESCRIPTION |
| | TITLE SHEET |
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| 6-7 | LEVEE TYPICAL SECTIONS- 1-2 |
| 8 | CAP TYPICAL SECTIONS |
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| | AND SPRINT LINE CROSSING DETAILS |
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| | |
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U. S. ARMY ENGINEER DISTRICT, NEW DRLEAN CORPS OF ENGINEERS NEW ORLEANS, LOUISIANA HIGH LEVEL PLAN I7TH STREET CANAL
EXCAVATION AND FLOODWALL PROTECTION
CAPPING OF FLOODWALLS
EAST SIDE LEVEE IMPROVEMENTS TITLE SHEET

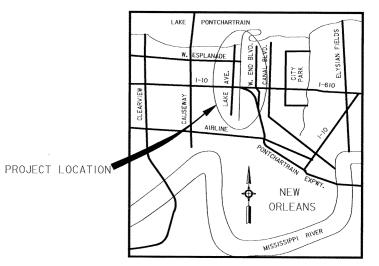

APPROVED BY:

CHIEF, DESIGN BRANCH DACW29- 93-B-0025 CHIEF, ENGINEERING DIVISION OLONEL, C. E. DISTRICT ENGINEER DEG. | 07 | 16

H-4-40208

GENERAL NOTES: I. ALL REFERENCES TO WALL LINE (W/L) REFER 6. THE CONTRACTOR SHALL NOTE THE CLOSE PROXIMITY OF RESIDENCES, TREES, AND TO THE CENTERLINE OF THE EXISTING SHEET PILE WALL ON THE ORLEANS LEVEE OF THE UTILITIES ALONG THE ENTIRE LENGTH OF THE PROJECT SITE. HE SHALL EXERCISE EXTREME CAUTION AT ALL TIMES WHEN WORKING ON THE 17TH STREET CANAL. STATIONING ALONG THE WALL IS BASED ON THE THEORETICAL WIDTH OBSTRUCTIONS TO R/W LEVEE AND HE SHALL BE RESPONSIBLE FOR THE REPAIR OF ANY DAMAGE RESULTING FROM OF THE SHEETS (BZ12.IL AND HOESCH 12 ARE 22.64"; PMA-22 IS 19.625") W/L STATION ITEM AND OWNER DISPOSITION HIS OPERATIONS. 2. ELEVATIONS REFER TO NATIONAL GEODETIC U.S. SPRINT FIBER OPTIC LINE DWG. NO. 2 VERTICAL DATUM (N.G.V.D.). ELEVATION AT U.S.C.E. MONUMENT 14 IS 8.77 N.G.V.D.. DWG. NO. 4 35+82 L.P.& L. POWER LINE 7. CONTRACTOR SHALL PROVIDE, ERECT, AND MAINTAIN A SAFETY FENCE AROUND THE CONSTRUCTION 3. NORMAL WATER SURFACE ELEVATION RANGE IS FROM EL.1.5 TO EL.2.0 (N.G.V.D.).. RIGHT-OF-WAY. SEE SPECIAL CLAUSE "SAFETY PROVISIONS". 4. REFERENCES TO THE PROTECTED SIDE OF THE LEVEE REFER TO THE LAND SIDE OF THE LEVEE. 8. SEE DRAWING 5 FOR BENCH MARK INFORMATION. REFERENCES TO THE FLOOD SIDE OF THE LEVEE REFER TO THE CANAL OR LAKE SIDE OF THE LEVEE. 5. THE CONTRACTOR SHALL REMOVE THE COAL TAR EPOXY PAINT FROM THE EXISTING SHEET PILE AS SPECIFIED IN "STEEL SHEET PILING" OF THE SPECIFICATIONS. 17TH STREET CANAL FLOW END EXIST. SHEET PILE W/L STA.97+62.05 FI AND CIDE FLOOD SIDE CONSTRUCTION R/W -END CONCRETE CAP W/L STA.97+75.13 -P.I. W/L STA.125+83.14 CONSTRUCTION R/W BURIED U.S. SPRINT FIBER OPTIC LINE W/L 99+71+/-P.I. W/L STA.118+27.58 -P.I. W/L STA.112+24.11-REQ'D SAFETY FENCE WITH EROSION CONTROL (SEE DWG. NO. 10 FOR DETAILS)-PROTECTED SIDE ---BEGIN CONCRETE CAP W/L STA.126+02.51 (PROTECTED SIDE ONLY, SEE SECTION BELOW) 4 EXIST. & NEW FLOODWALL -ACCESS SITE --PUMPING STA. NO.6. (SEE DWG. NOS.15 & 16 FOR DETAILS) -BELLAIRE DR. PLAN SCALE I"= 100'-0" DEGRADE PROTECTED SIDE OF LEVEE TO THE ALLOWABLE STRUCTURAL EXCAVATION LIMITS (2'-4"), TO ALLOW FOR ACCESS ROAD, W/L STA.126+00 TO W/L STA. 97+52 PROTECTED SIDE CONSTRUCTION R/W-SAFETY FENCE EXISTING SHEET PILE EROSION CONTROL BALES -SHEET PILE TO BE CAPPED ---- SHEET PILE LEFT UNCAPPED 35' CONSTRUCTION R/W ---- CONSTRUCTION R/W U. S. ARMY ENGINEER DISTRICT, NEW DRLEANS H*H CORPS OF ENGINEERS NEW ORLEANS, LOUISIANA EXCAVATED MATERIAL MUST BE HAULED IN ACCORDANCE ----- UTILITY WITH C2C OF THE SPECIFICATIONS AND STORED FOR STA.116+00 TO STA.98+00 SHOWN. OTHERS AREAS SIMILAR. REUSE IN ACCORDANCE WITH SPECIAL CLAUSE "OFFSITE STORAGE". ----- CONSTR. R/W AND SAFETY FENCE ORLEANS LEVEE DISTRICT NEW ORLEANS, LOUISIANA ACCESS AND STORAGE DETAILS LAKE PONTCHARTRAIN, LA. AND VICINITY
HIGH LEVEL PLAN STA.126+03 TO STA.97+52 SCALE I"= 10'-0" I7TH STREET CANAL EXCAVATION AND FLOODWALL PROTECTION CAPPING OF FLOODWALLS ACCESS NOT SHOWN FOR CLARITY SCALE: 1" - 100' EAST SIDE LEVEE IMPROVEMENTS 100' 200' 300' PLAN-I AND GENERAL NOTES SCALE: 1" - 10' ESIGNED BY: F.S. FO ADD NOV. 1992 | 1200 CHECKED BY: M.L.S.

MODJESKI & MASTERS Inc. NEW ORLEANS, LOUISIANA

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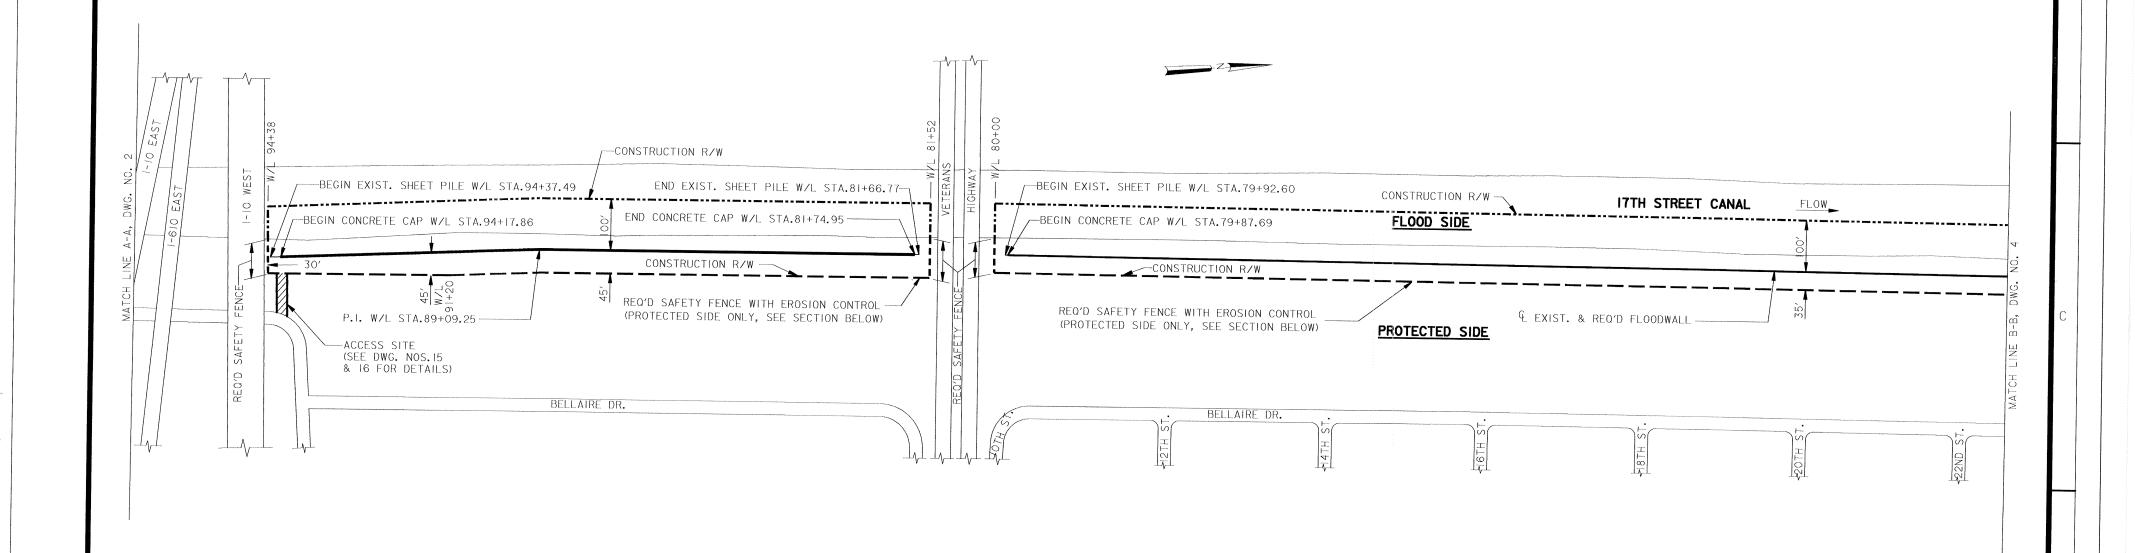
DACW29-93-B-0025

SOLICITATION NO

APR 1993

H-4-40208

owg. 2 of



PLAN SCALE I"= 100'-0"

STORAGE AREA FOR EXCAVATED MATERIAL FROM STA.89+00 TO PROTECTED SIDE DEGRADE PROTECTED SIDE OF LEVEE FLOOD SIDE STA.81+52. CONTRACTOR TO PROVIDE DRAINAGE THROUGH TO THE ALLOWABLE STRUCTURAL EXCAVATION MATERIAL EVERY 100 FEET. (APPROX. 330 C.Y.) MATERIAL TO BE REUSED. LIMITS (2'-4"), TO ALLOW FOR ACCESS ROAD, STA.94+38 TO STA.81+52 CONSTRUCTION R/W EXISTING SHEET PILE SAFETY FENCE EROSION CONTROL BALES -10' 2'+/-EXCAVATED MATERIAL NOT SPREAD ON LEVEE 45' CONSTRUCTION R/W SHOWN BACKSLOPE MUST BE HAULED IN ACCORDANCE WITH R/W VARIES (SEE PLAN) C2C OF THE SPECIFICATIONS AND STORED FOR REUSE IN ACCORDANCE WITH SPECIAL CLAUSE STA.89+20 TO STA. 81+75 SHOWN. OTHER AREAS SIMILAR.

MATERIAL EXCAVATED FROM BELOW EL.2.0 IS TO BE HAULED IN ACCORDANCE WITH C2C-4.9.

ACCESS AND STORAGE DETAILS

STA.94+38 TO STA.81+52 SCALE I"= 10'-0" ACCESS NOT SHOWN FOR CLARITY

LEGEND

SHEET PILE TO BE CAPPED SHEET PILE LEFT UNCAPPED

----- CONSTRUCTION R/W

----- UTILITY

— — - CONSTR. R/W, SAFETY FENCE, EROSION CONTROL

----- CONSTR. R/W AND SAFETY FENCE

SCALE: 1" - 100' 100' 200' 300' 400'

SCALE: 1" - 10'

U. S. ARMY ENGINEER DISTRICT, NEW DRLEAN HAH CORPS OF ENGINEERS NEW ORLEANS, LOUISIANA BOARD OF LEVEE COMMISSIONERS ORLEANS LEVEE DISTRICT NEW ORLEANS, LOUISIANA

DESCRIPTION

MODJESKI & MASTERS Inc. NEW ORLEANS, LOUISIANA LAKE PONTCHARTRAIN, LA. AND VICINITY HIGH LEVEL PLAN I7TH STREET CANAL
EXCAVATION AND FLOODWALL PROTECTION
CAPPING OF FLOODWALLS
EAST SIDE LEVEE IMPROVEMENTS

PLAN-2

DESIGNED BY: F.S. APR 1993 DRAWN BY: P.M.R. NOV. 1992 1200 CHECKED BY: M.L.S. CADD FILE: 40208X03.DGN H-4-40208 SUBMITTED BY:
W. B. CONWAY
MODJESKI & MASTERS Inc.
DESIGN ENGINEER SOLICITATION NO. DACW29-93-B-0025 DWG. 3 OF 16

40200X03.DSN 10/09/2005 01:14:32 PM

"OFFSITE STORAGE".

2 4 5 FLOW CONSTRUCTION R/W-P.I. W/L STA.58+95.30 17TH STREET CANAL FLOOD SIDE -STORAGE AREA (SEE DETAIL, THIS SHEET) REQ'D SAFETY FENCE WITH EROSION CONTROL (PROTECTED SIDE ONLY, SEE SECTION BELOW) PROTECTED SIDE -ACCESS SITE (SEE DWG. NOS.15 & 16 FOR DETAILS -OVERHEAD LP&L & 16 FOR DETAILS) & POWERLINE. W/L 35+82+/-REQ'D SAFETY FENCE WITH GATE PLAN SCALE I" = 100'-0" DEGRADE PROTECTED SIDE OF LEVEE TO THE ALLOWABLE STRUCTURAL EXCAVATION LIMITS (2'-4"), TO ALLOW FOR ACCESS ROAD, STA.80+00 TO STA.40+13 STORAGE AREA STA.59+10 TO STA.59+40. (APPROX. 520 C.Y.) EROSION CONTROL BALES EXISTING SHEET PILE MATERIAL TO BE REUSED. 30' CONSTRUCTION R/W (VARIES - SEE PLAN) LEGEND EXCAVATED MATERIAL NOT SPREAD ON LEVEE CONSTRUCTION R/W BACKSLOPE MUST BE HAULED IN ACCORDANCE WITH SHEET PILE TO BE CAPPED C2C OF THE SPECIFICATIONS AND STORED FOR DATE --- SHEET PILE LEFT UNCAPPED REUSE IN ACCORDANCE WITH SPECIAL CLAUSE U. S. ARMY ENGINEER DISTRICT, NEW DRLEANS "OFFSITE STORAGE". ----- CONSTRUCTION R/W ACCESS RAMP AT STA.58+50 - SEE DWG. NO.16 FOR DETAILS. HYH MATERIAL EXCAVATED FROM BELOW EL.2.0 IS ----- UTILITY CORPS OF ENGINEERS NEW ORLEANS, LOUISIANA TO BE HAULED IN ACCORDANCE WITH C2C-4.9. STA.80+00 TO STA.69+93 SHOWN. OTHER AREAS SIMILAR. - - CONSTR. R/W, SAFETY FENCE, EROSION CONTROL ---- CONSTR. R/W AND SAFETY FENCE MODJESKI & MASTERS Inc. NEW ORLEANS, LOUISIANA LAKE PONTCHARTRAIN, LA. AND VICINITY
HIGH LEVEL PLAN ACCESS AND STORAGE DETAILS SCALE: 1" - 100' ITH STREET CANAL
EXCAVATION AND FLOODWALL PROTECTION
CAPPING OF FLOODWALLS
EAST SIDE LEVEE IMPROVEMENTS STA.80+00 TO STA.40+13 SCALE I" = 10'-0" 100' 200' 300' 400' ACCESS NOT SHOWN FOR CLARITY PLAN-3 SCALE: 1" - 10' C·A·D 10' 20'

DESIGNED BY: F.S.

DRAWN BY: P.M.R. CHECKED BY: M.L.S.

SUBMITTED BY: W. B. CONWAY MODJESKI & MASTERS Inc

NOV. 1992 1200

DACW29-93-B-0025

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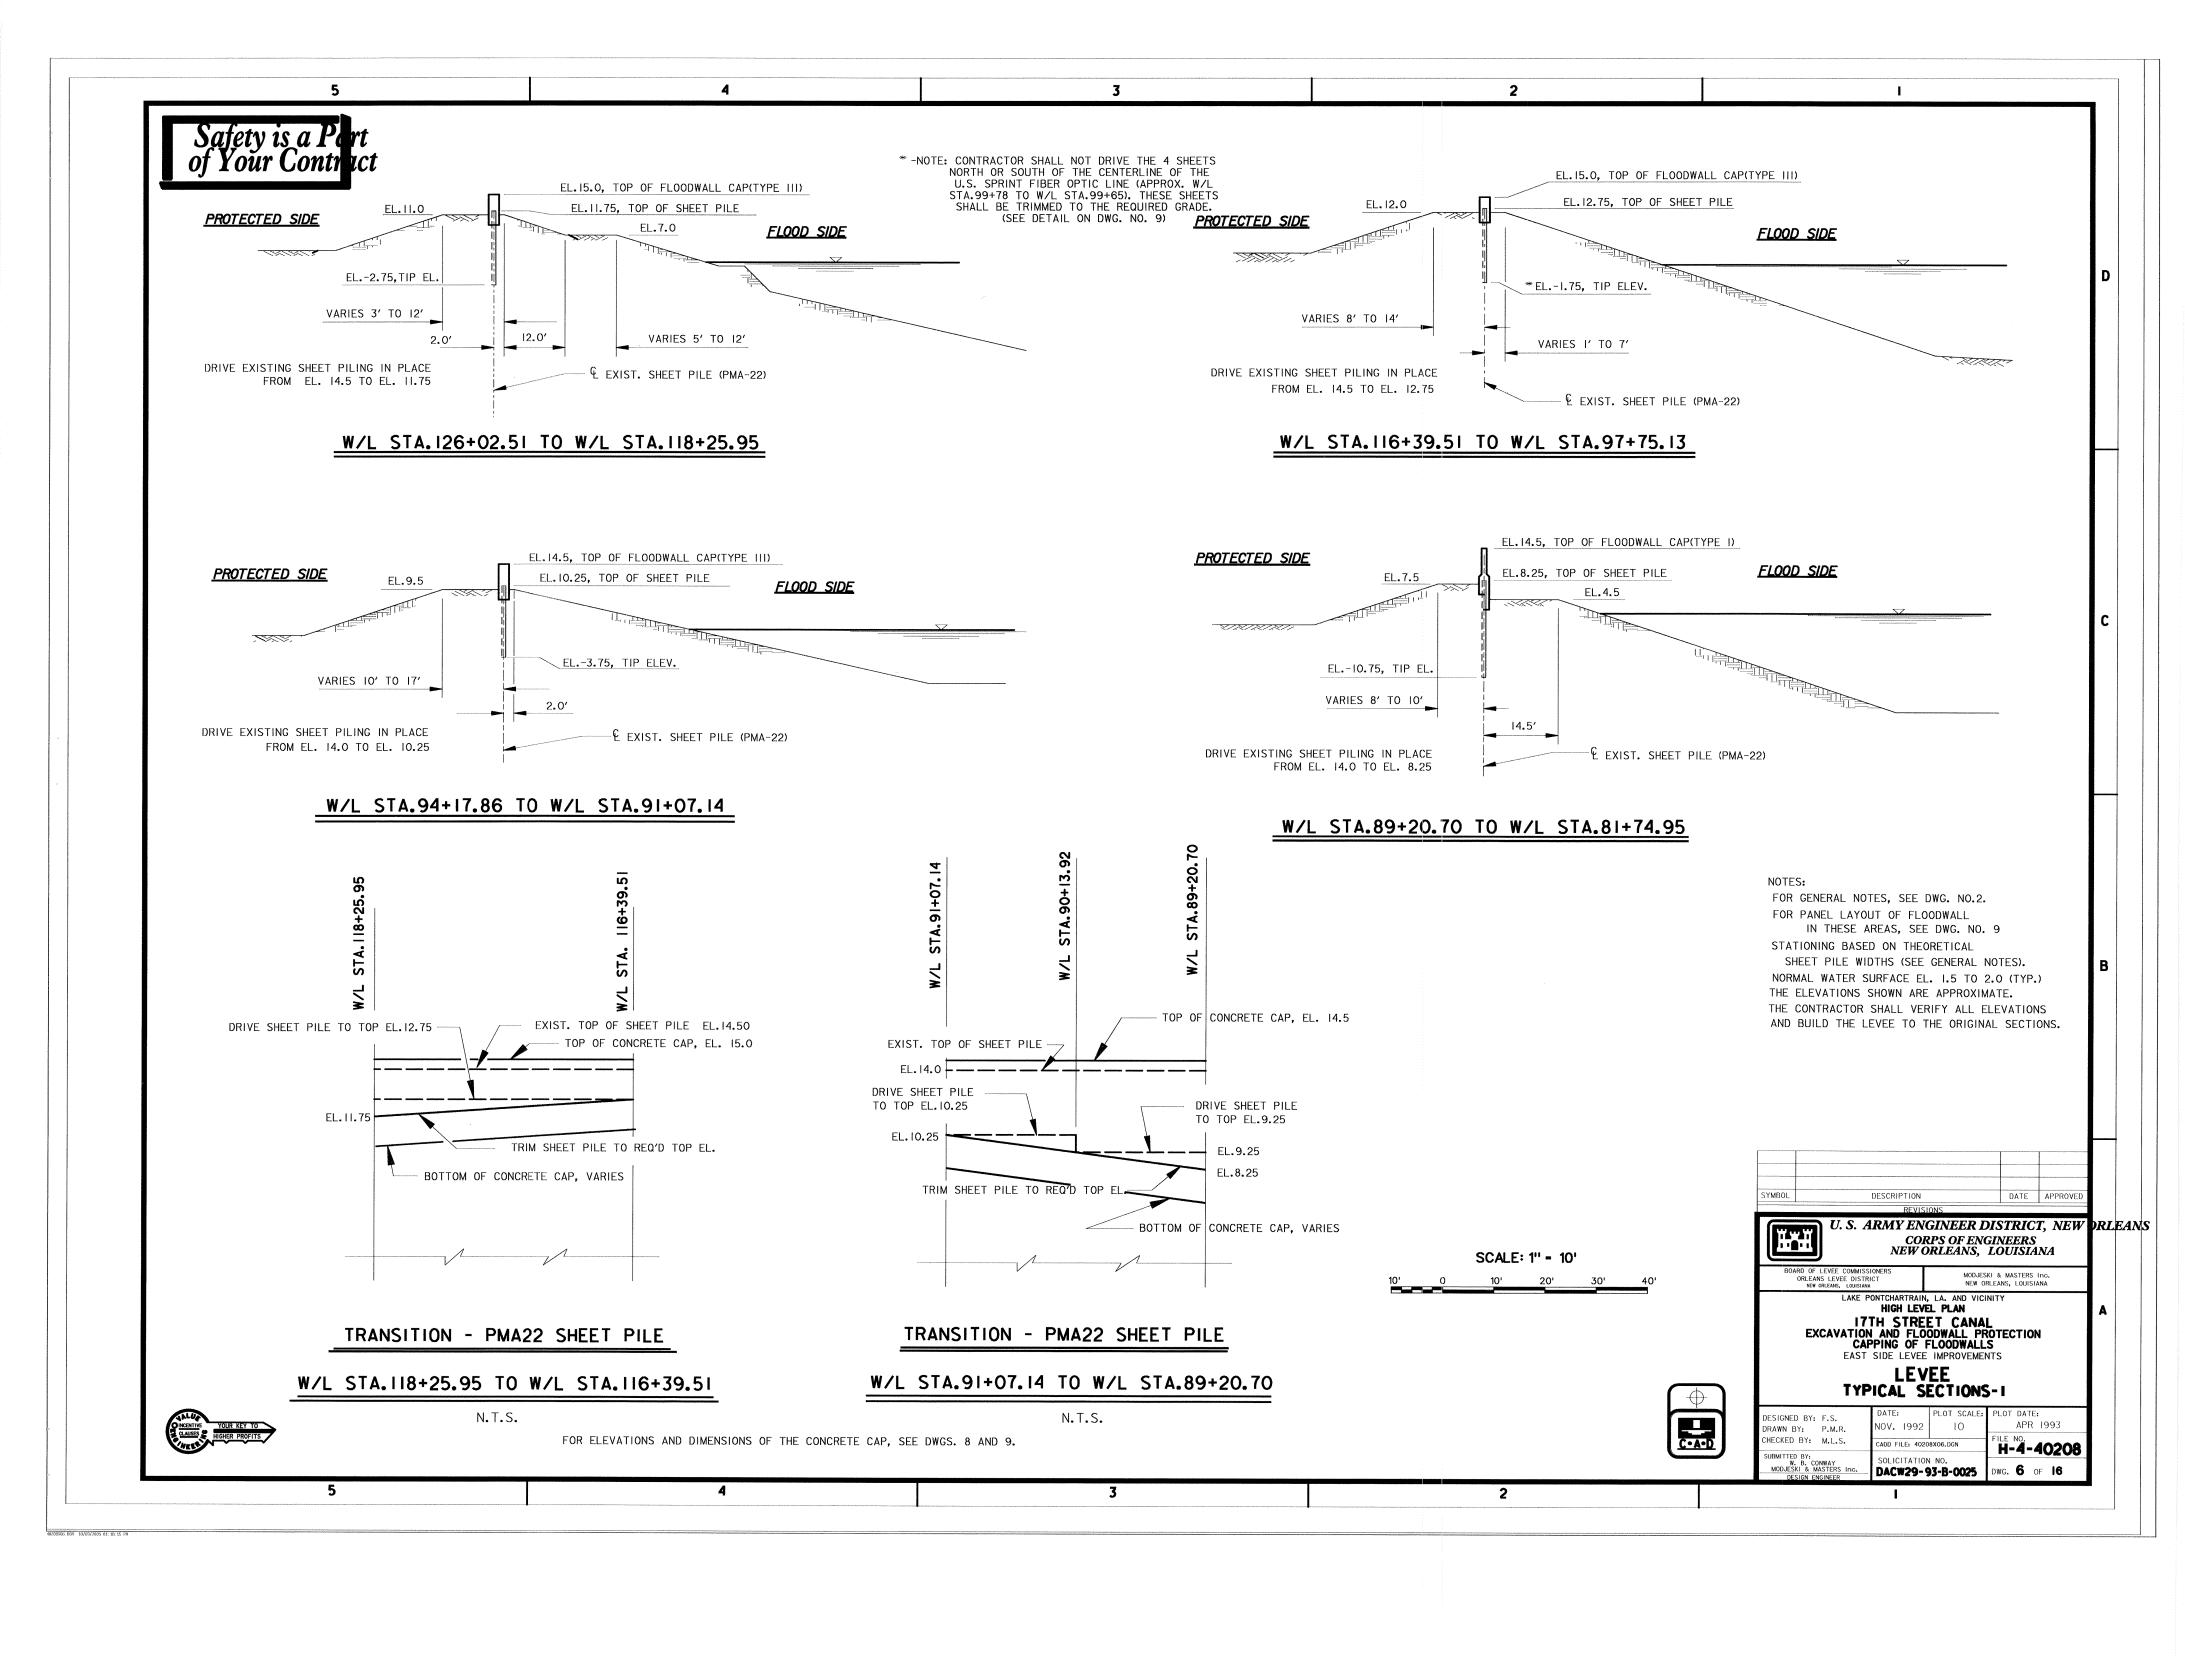
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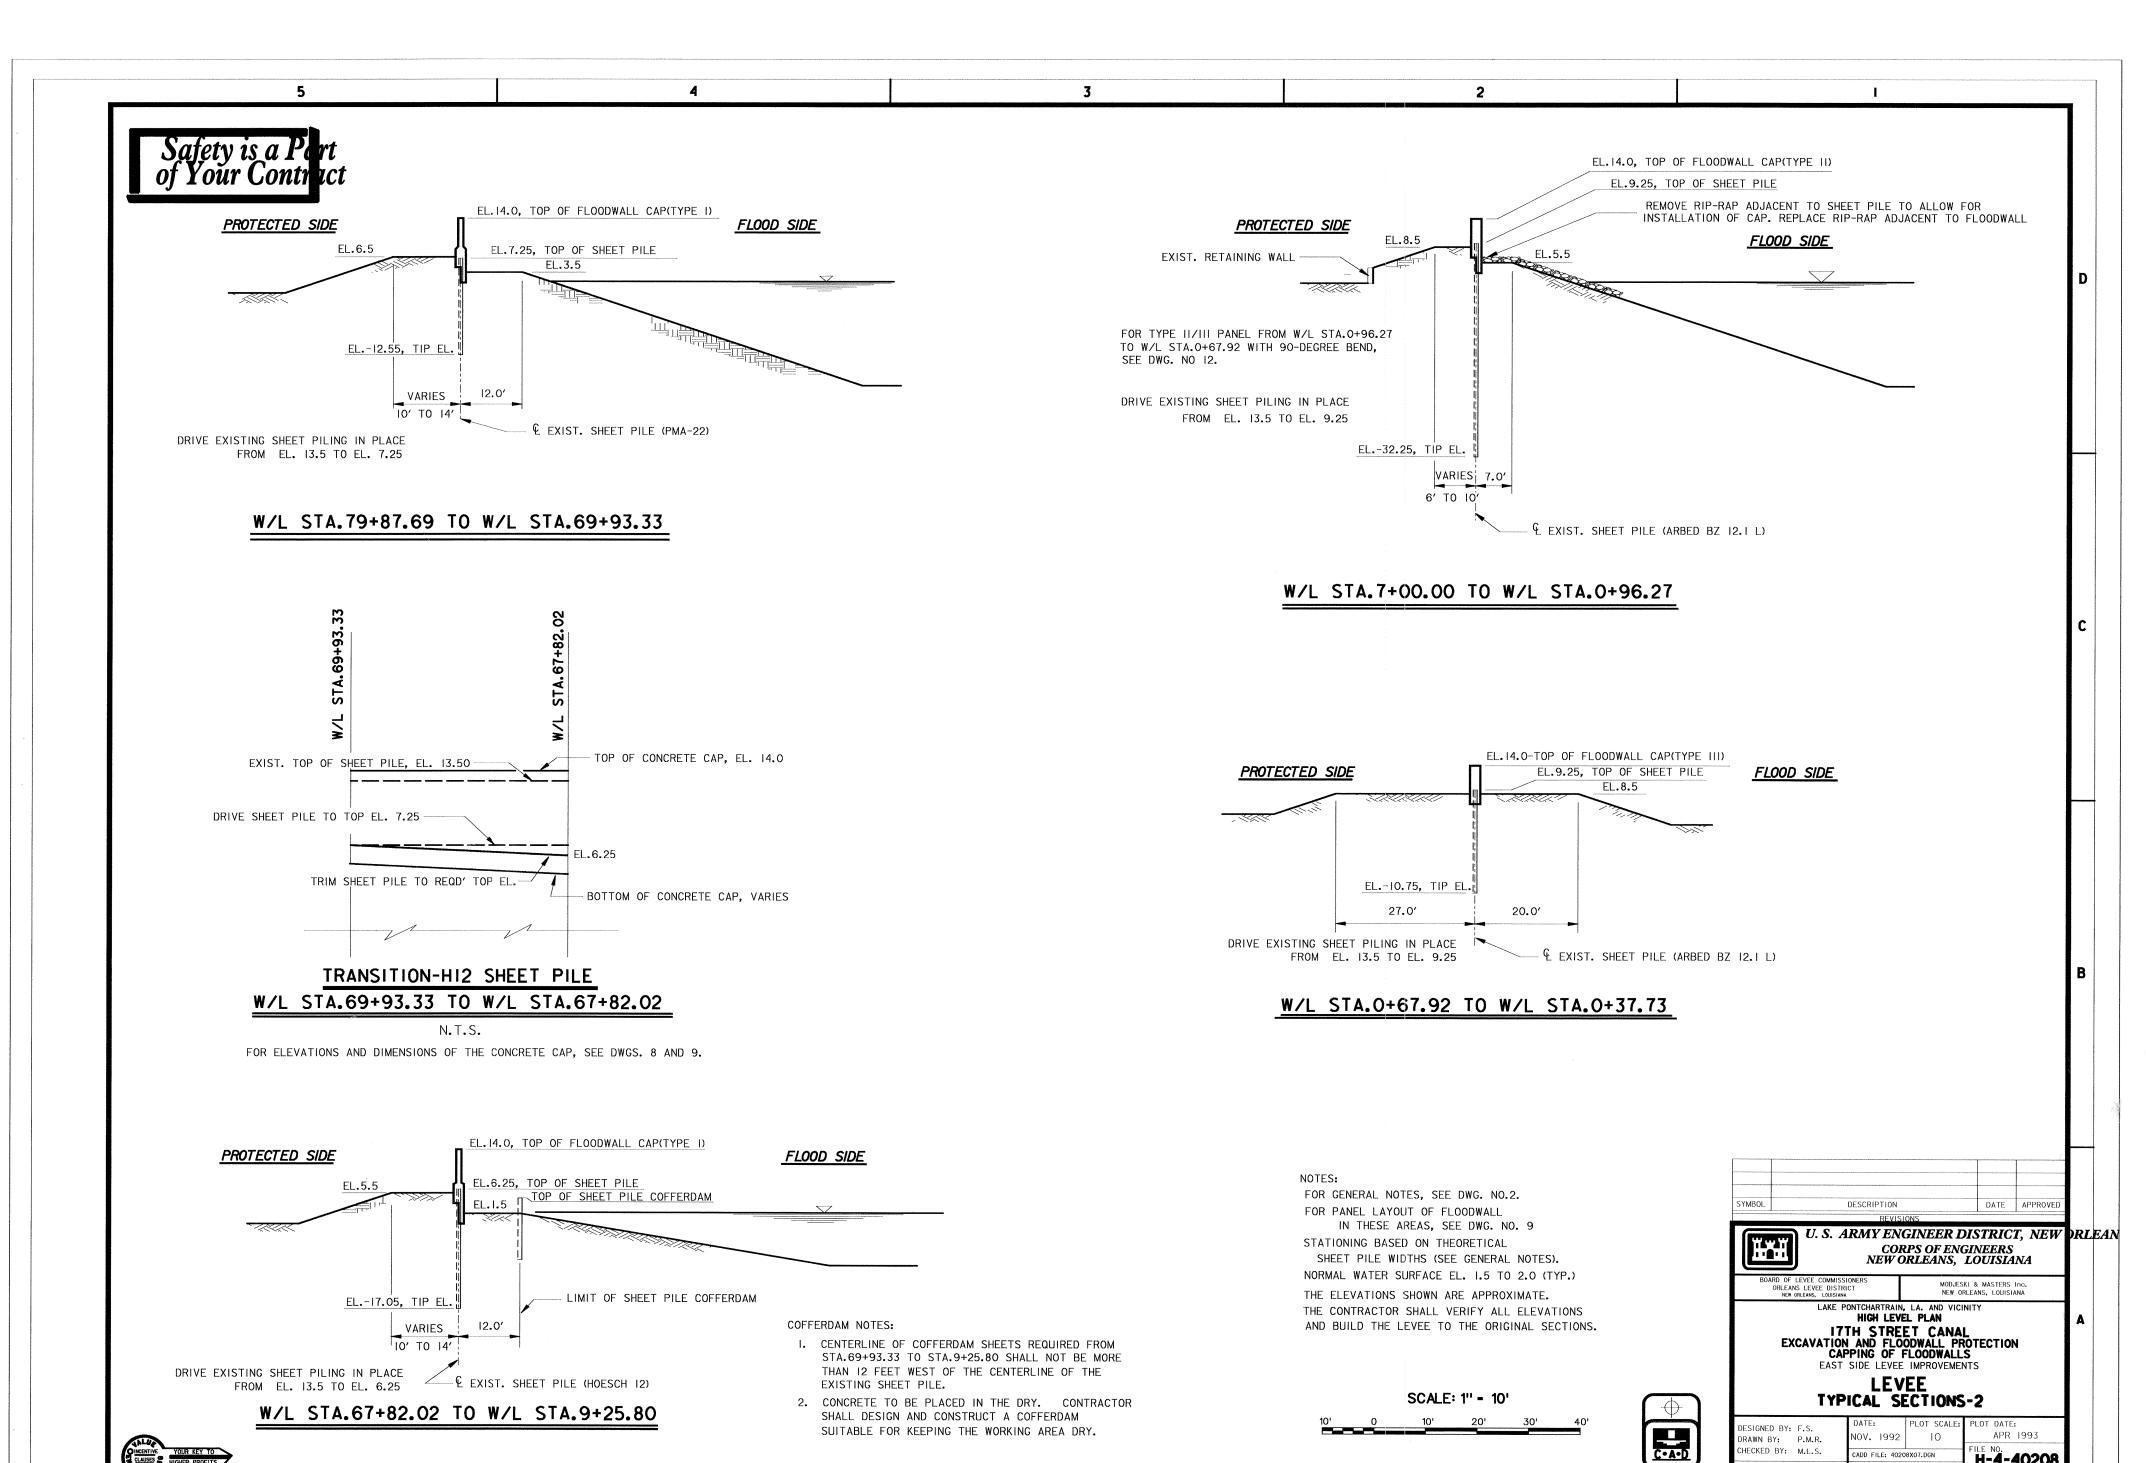
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DWG. 4 OF 16

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LAKE PONTCHARTRAIN -USCE MON. 14 226' WEST OF W/L STA.5+11.80 OR 247' NORTH OF N.W. CORNER OF HAMMOND HWY. BRIDGE NORTH ABUTMENT. EL.= 8.77 N.G.V.D. BEGIN EXIST. SHEET PILE W/L STA.7+03.78 __BEGIN CONCRETE CAP W/L STA.7+00.00 FLOW -CONSTRUCTION R/W ·-··-· P.I. W/L STA.21+27.62 17TH STREET CANAL -CONSTRUCTION R/W END EXIST. SHEET PILE , W/L STA. 8+48.45-FLOOD SIDE END CONCRETE CAP W/L STA.9+25.80-P.I. W/L STA.0+72.69 REO'D SAFETY FENCE WITH EROSION CONTROL (PROTECTED SIDE ONLY, SEE SECTION BELOW) -CONSTRUCTION R/W -END CONCRETE CAP W/L STA.O+37.73 PROTECTED SIDE REQ'D SAFETY FENCE WITH EROSION CONTROL — € EXIST. & NEW FLOODWALL END EXIST. SHEET PILE W/L STA.0+00.00 (PROTECTED SIDE ONLY, SEE SECTION BELOW) STORAGE AREA (SEE DETAIL, THIS SHEET) REQ'D SAFETY FENCE - ACCESS SITE (SEE DWG. NOS.15 & 16 FOR DETAILS) - REQ'D SAFETY FENCE REQ'D SAFETY FENCE WITH EROSION CONTROL
(PROTECTED SIDE ONLY, SEE SECTION BELOW) PLAN LEGEND SHEET PILE TO BE CAPPED SHEET PILE LEFT UNCAPPED ----- CONSTRUCTION R/W ----- UTILITY ------ CONSTR. R/W, SAFETY FENCE, EROSION CONTROL DEGRADE PROTECTED SIDE OF LEVEE ---- CONSTR. R/W AND SAFETY FENCE TO THE ALLOWABLE STRUCTURAL EXCAVATION LIMITS (2'-4") , TO ALLOW FOR ACCESS ROAD, STORAGE AREA STA.2+80 TO STA.1+30 (APPROX. 250 C.Y.) HAMMOND HWY. TO STA.I+OO. SCALE: 1" - 100' MATERIAL TO BE REUSED. CONTRACTOR TO PROVIDE 100' 200' 300' DRAINAGE THROUGH MATERIAL CONTROL AT STA.2+05 STORAGE AREA FOR RIP-RAP DURING SAFETY BALES EROSION CONTROL -STORAGE AREA FOR EXCAVATION SCALE: 1" - 10' FENCE CAP CONSTRUCTION. CONSTRUCTION R/W MATERIAL - DEPTH OF 6 INCHES STA.40+13 TO STA.10+86 APPROX. 430 C.Y.) MATERIAL EROSION CONTROL BALES-TO BE REUSED. SAFETY..... SAFETY FENCE **FENCE** 25' CONSTR. R/W HAMMOND HWY. CONSTRUCTION R/W -EXISTING SHEET PILE TO STA.3+00 EXISTING SHEET PILE 50' CONSTRUCTION R/W SYMBOL DATE APPROVED DESCRIPTION R/W VARIES STA.3+00 TO STA.1+08+/-SEE PLAN U. S. ARMY ENGINEER DISTRICT, NEW DRLEAN HYH RETAINING WALL 27'+/- EAST OF SHEET PILE FROM STA.7+04 CORPS OF ENGINEERS NEW ORLEANS, LOUISIANA TO STA.3+35 NOT SHOWN FOR CLARITY. EXCAVATED MATERIAL IN EXCESS OF STORAGE IN THIS REACH TO BE HAULED IN ACCORDANCE WITH SECTION C2C OF THE SPECIFICATIONS AND STORED FOR REUSE IN ACCORDANCE MATERIAL EXCAVATED FROM BELOW EL.2.0 IS TO BE HAULED IN LAKE PONTCHARTRAIN, LA. AND VICINITY ACCORDANCE WITH C2C-4.9. WITH THE SPECIAL CLAUSE "OFFSITE STORAGE". HIGH LEVEL PLAN ITTH STREET CANAL
EXCAVATION AND FLOODWALL PROTECTION
CAPPING OF FLOODWALLS
EAST SIDE LEVEE IMPROVEMENTS ACCESS AND STORAGE DETAILS ACCESS AND STORAGE DETAILS STA.40+13 TO HAMMOND HIGHWAY HAMMOND HWY. TO STA.0+00 SCALE I" = 10'-0" PLAN-4 SCALE I" = 10'-0" STORAGE ON LEVEE NOT SHOWN ON PLAN FOR CLARITY. ACCESS NOT SHOWN ON PLAN FOR CLARITY DESIGNED BY: F.S. C•A•D APR 1993 NOV. 1992 1200 DRAWN BY: P.M.R. CHECKED BY: M.L.S. CADD FILE: 40208X05.DGN H-4-40208 DWG. 5 OF 16 DACW29-93-B-0025







DRAWN BY: P.M.R. CHECKED BY: M.L.S.


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CADD FILE: 40208X07.DGN SOLICITATION NO. DACW29-93-B-0025 H-4-40208

DWG. 7 OF 16



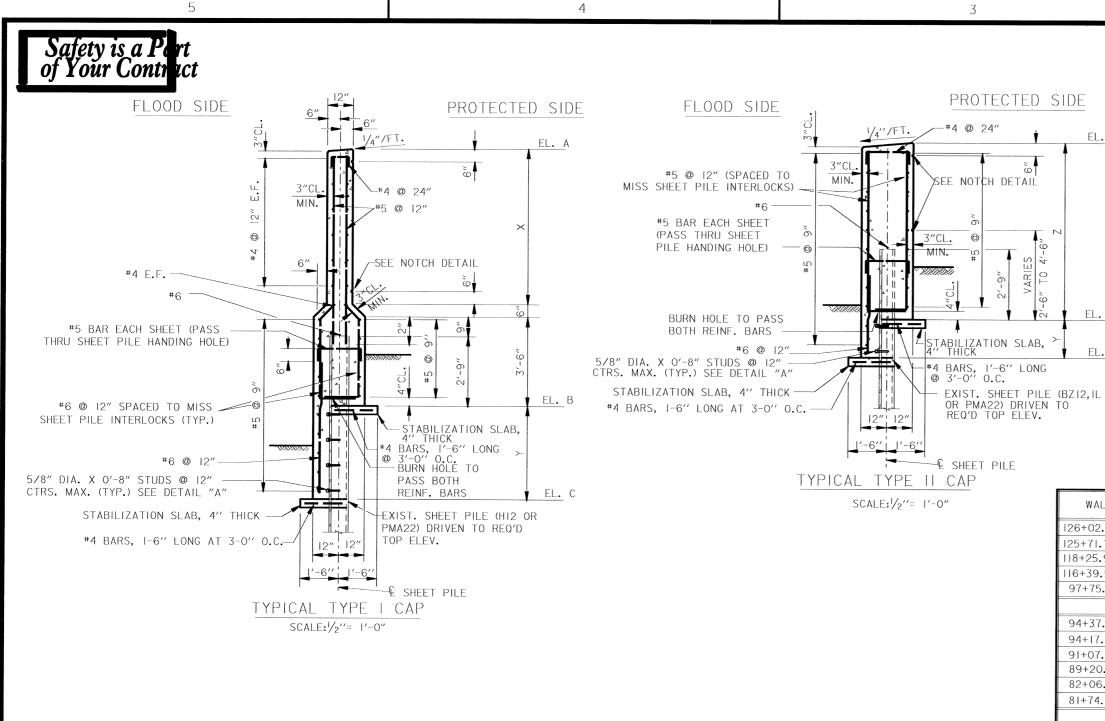

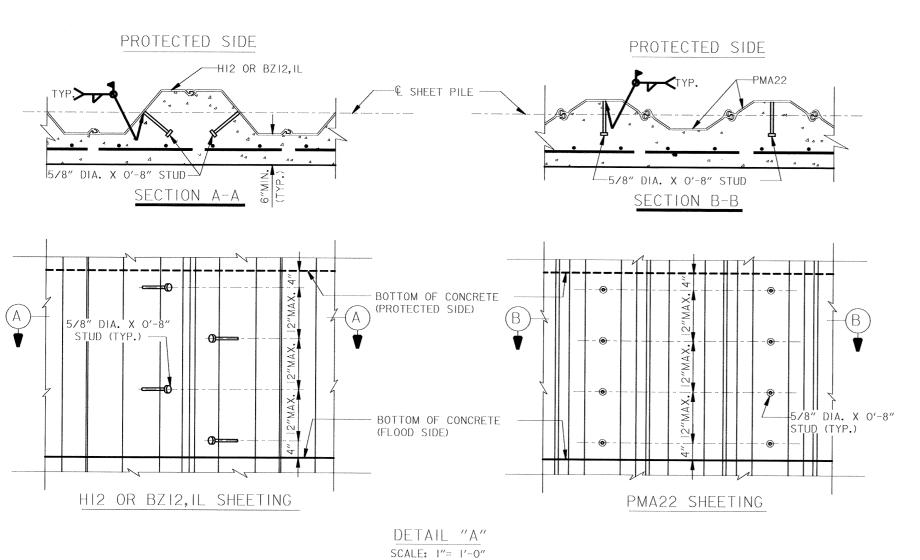
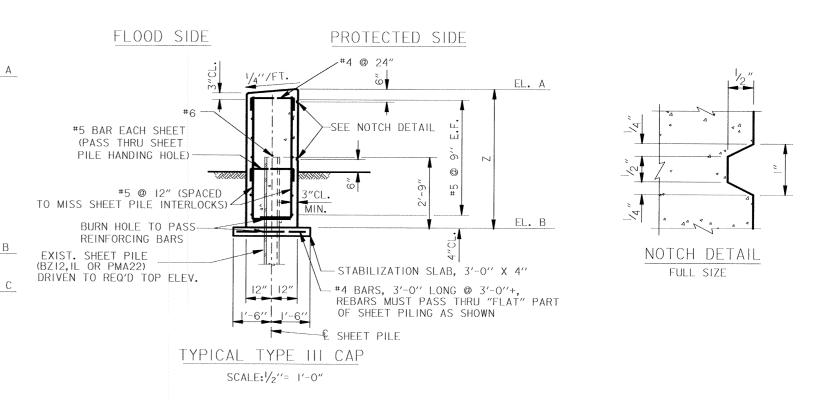
| | | - | *************************************** | | | | | |
|------------------------|------------------------|--------|---|---------------|--------------|-----------------|--|--|
| WALL LINE STATION | WALL | WALL | ELEV. | ELEV. | ELEV. | X | Y | Z |
| | LENGTH | TYPE | A | В | С | (FT.) | (FT.) | (FT.) |
| 126+02.51 TO 125+71.70 | 30′-9 3⁄4 ″ | 111 | 15.0 | 9.0 | | *** *** | THE ARE NOT | 6′-0″ |
| 125+71.70 TO 118+25.95 | 745′-9 ″ | 111 | 15.0 | 9.0 | | 274 And prop | many many many | 6′-0″ |
| 118+25.95 TO 116+39.51 | 186'-5 1/4" | | 15.0 | 9.0 TO 10.0 | ATR 500 MIL. | Tro, may pas. | ATTA DISA | 6"-0" TO 5'-0" |
| 116+39.51 TO 97+75.13 | 1864'-4 1/2" | 111 | 15.0 | 10.0 | *** *** *** | | Pro You dia | 5'-0" |
| 97+75.13 TO 97+62.05 | 13'-1 " | | | | SHEET PILE | ONLY | | |
| | | | INTERS | STATE BRIDGES | 5 | | Account of the second of the s | |
| 94+37.49 TO 94+17.86 | 19'-7 1/2" | | | | SHEET PILE | ONL Y | | 4.04 |
| 94+17.86 TO 91+07.14 | 310′-8 3/4 " | 111 | 14.5 | 7.5 | | | | 7'-0" |
| 91+07.14 TO 89+20.70 | 186′-5 1⁄4 ″ | | 14.5 | 7.5 TO 5.5 | 7.5 TO 2.5 | **** | 0'-0" TO 3'-0" | 7'-0" TO 9'-0" |
| 89+20.70 TO 82+06.02 | 714'-8 1/8" | | 14.5 | 5.5 | 2.5 | 5'-0" | 3'-0" | ETT TOO AND |
| 82+06.02 TO 81+74.95 | 31'-0 7/8 " | I | 14.5 | 5.5 TO 2.5 | 2.5 | 5'-0" | 3'-0" TO 0'-0" | |
| 81+74.95 TO 81+66.77 | 8'-2 1/8 " | | | | SHEET PILE | ONLY | | |
| | | | VETERANS | HIGHWAY BRIDG | GES | | | |
| 79+92.60 TO 79+87.69 | 4'-10 7/8" | | | | SHEET PILE | ONLY | | |
| 79+87.69 TO 79+56.62 | 31'-0 7/8" | I | 14.0 | 1.5 TO 4.5 | 1.5 | 5′-6″ | 0'-0" TO 3'-0" | arm dept. store |
| 79+56.62 T0 70+24.43 | 932'-2 1/4" | 1 | 14.0 | 4.5 | 1.5 | 5′-6″ | 3'-0" | Alak dana aran |
| 70+24.43 T0 69+93.33 | 31'-1 V ₄ " | l | 14.0 | 4.5 | 1.5 | 5′-6″ | 3'-0" | |
| 69+93.33 TO 67+82.02 | 211'-3 3/4" | 1 | 14.0 | 4.5 TO 3.5 | 1.5 TO -0.5 | 5'-6" TO 6'-6" | 3'-0" TO 4'-0" | We see by |
| 67+82.02 TO 9+55.99 | 5826′-2 1/4 " | - | 14.0 | 3.5 | -0.5 | 6′-6″ | 4'-0" | |
| 9+55.99 TO 9+25.80 | 30'-2 1/4" | 1 | 14.0 | 3.5 TO -0.5 | -0.5 | 6'-6" | 4'-0" TO 0'-0" | |
| | | | HAMMOND I | HIGHWAY BRIDG | BE. | | | |
| 7+03.78 TO 7+00.00 | 3'-9 1/4" | | | | SHEET PILE | ONLY | | THE STATE OF THE S |
| 7+00.00 T0 6+69.82 | 30'-2 1/4" | 11 | 14.0 | 3.5 TO 6.5 | 3.5 | *** **** **** | 0'-0" TO 3'-0" | 10'-6" TO 7'-6" |
| 6+69.82 TO 0+96.27 | 573'-6 3/4" | 11 | 14.0 | 6.5 | 3.5 | Ata | 3'-0" | 7′-6″ |
| 0+96.27 TO 0+67.92 | 28'-4 7/8" | / -* | 14.0 | 6.5 | 3.5 | | 3'-0" | 7'-6" |
| 0+67.92 TO 0+37.73 | 30'-2 1/4" | | 14.0 | 6.5 | | NOTE there were | Maria Strategic Company | 7′-6″ |
| 0+37.73 TO 0+00.00 | 37'-8 7/8" | | | | SHEET PILE | ONLY | | |

*-FOR DETAILS OF 90-DEGREE BEND, SEE DWG. NO. 12.

FOR GENERAL NOTES, SEE DWG. NO. 2.


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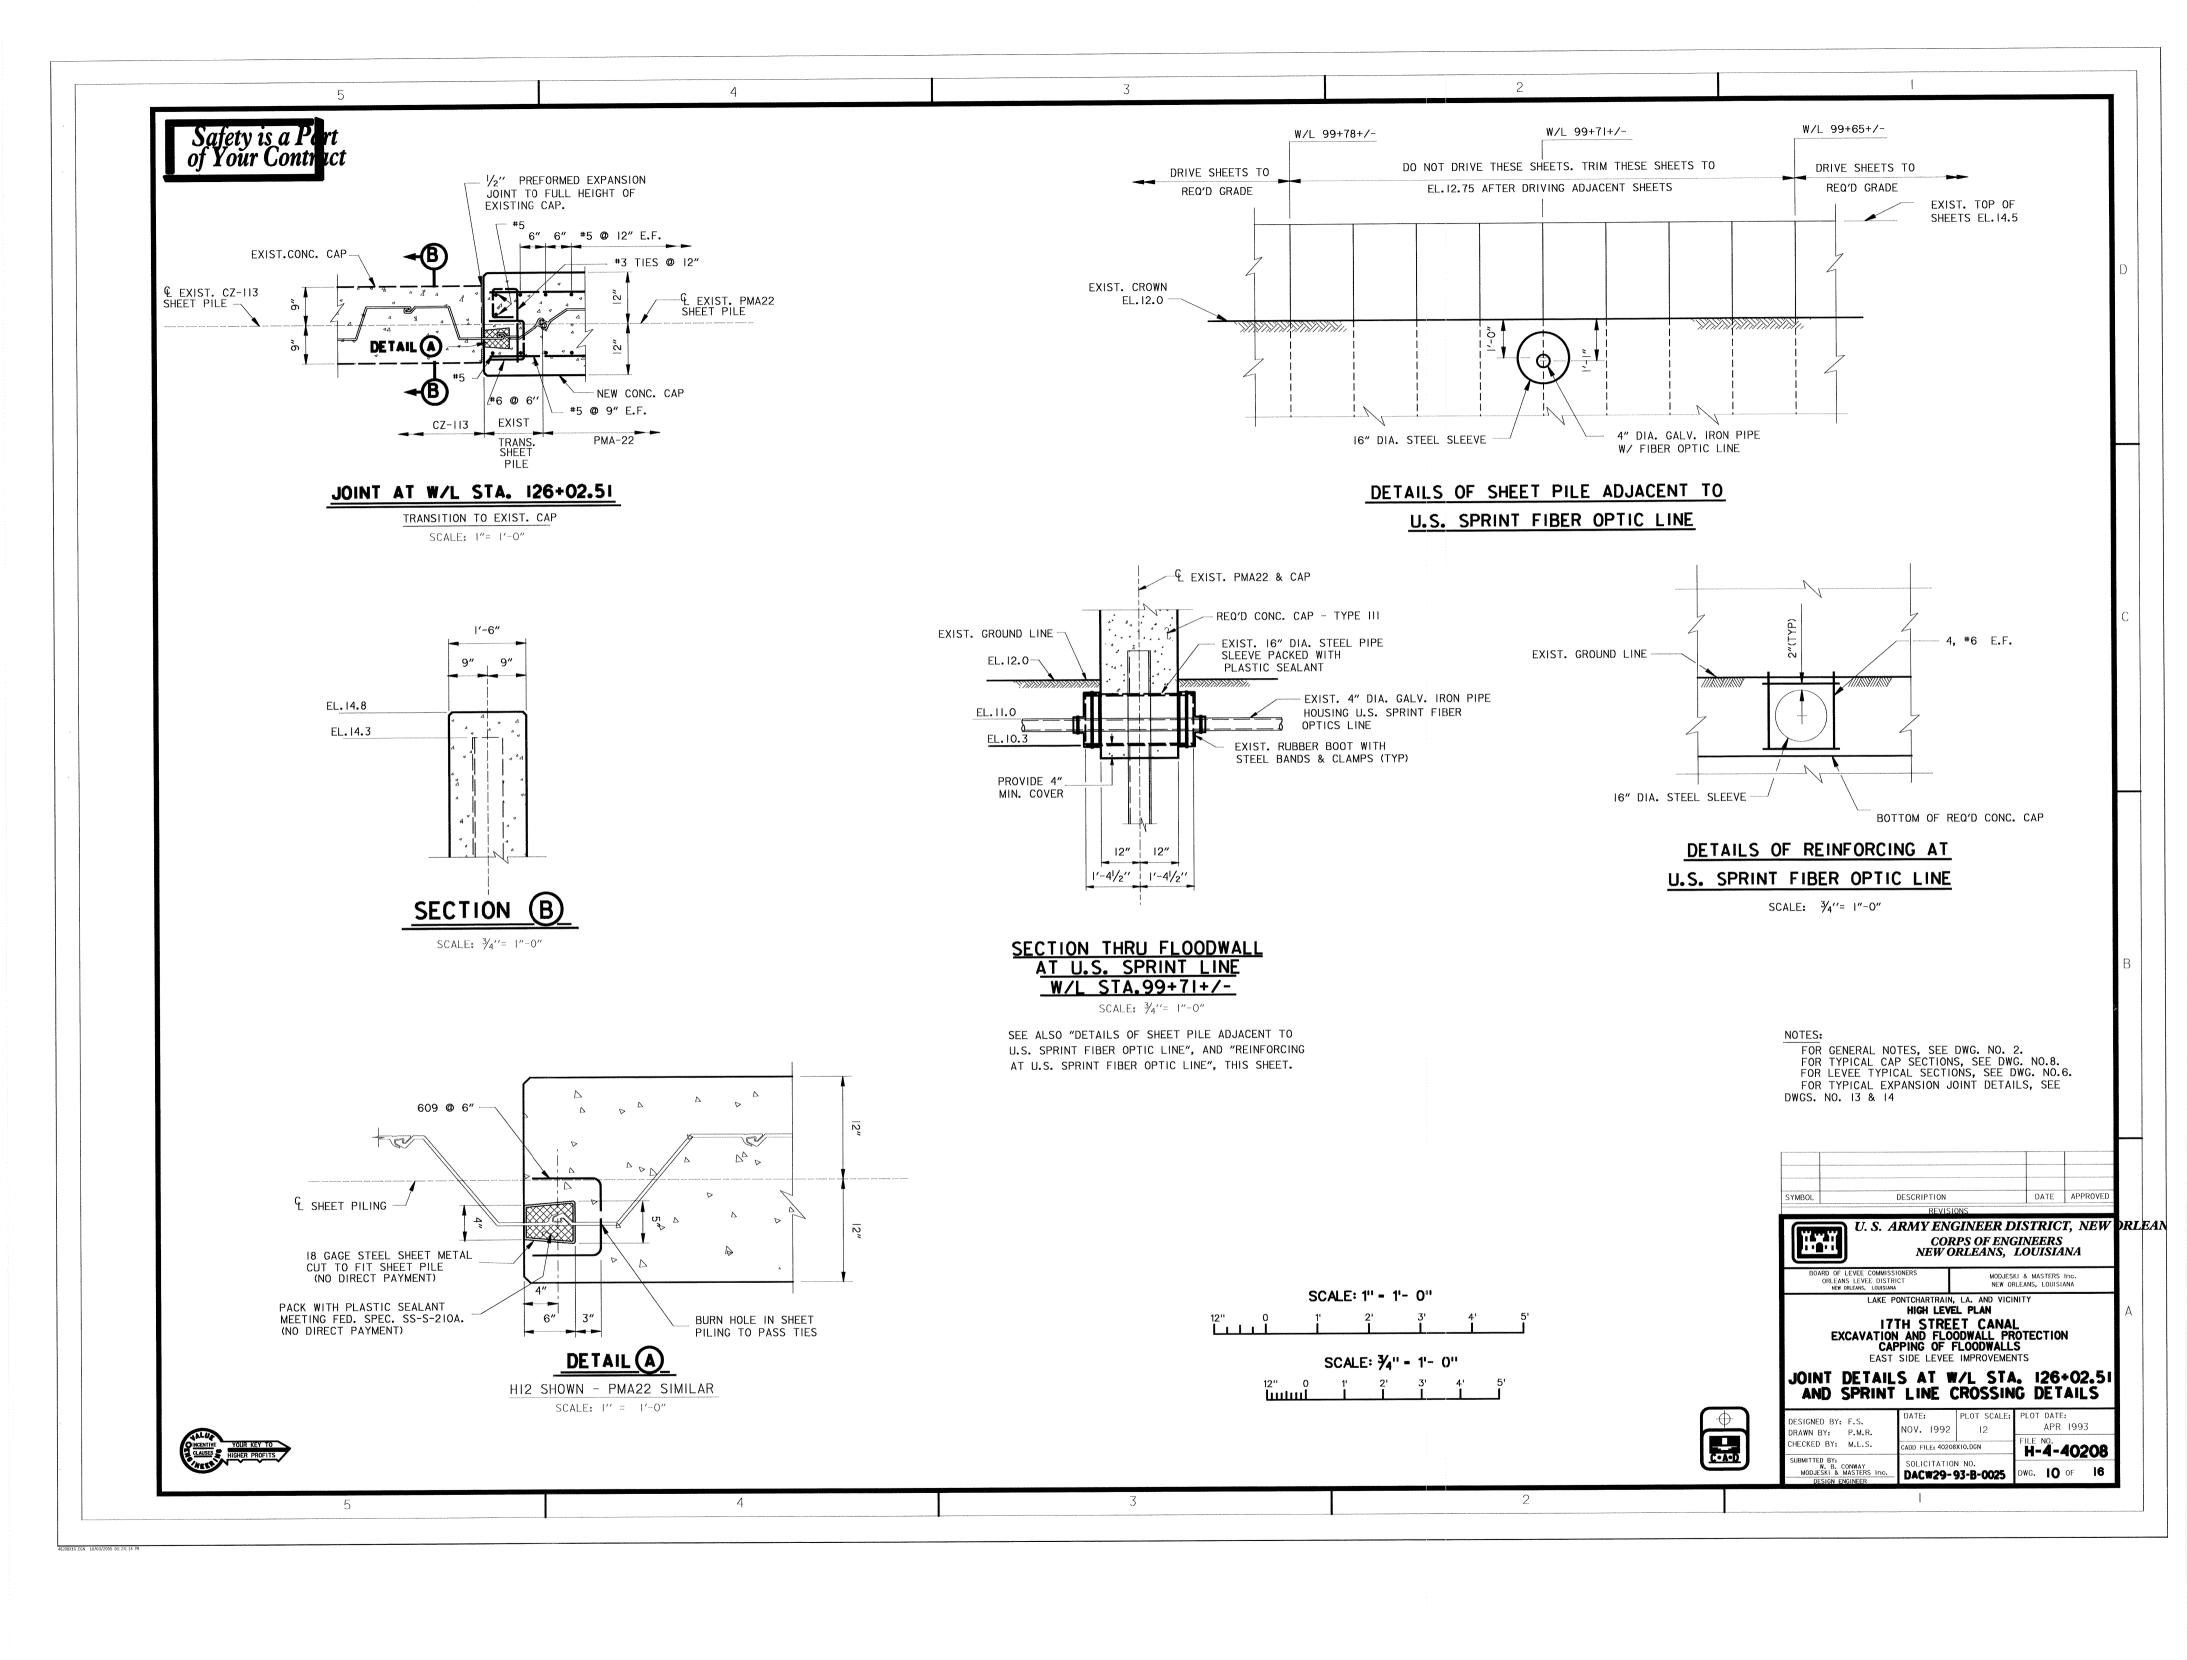
U. S. ARMY ENGINEER DISTRICT, NEW DRLEAMS CORPS OF ENGINEERS NEW ORLEANS, LOUISIANA


LAKE PONTCHARTRAIN, LA. AND VICINITY
HIGH LEVEL PLAN I7TH STREET CANAL
EXCAVATION AND FLOODWALL PROTECTION
CAPPING OF FLOODWALLS
EAST SIDE LEVEE IMPROVEMENTS


FLOODWALL CAP TYPICAL SECTIONS

DESIGNED BY: F.S. APR 1993 NOV. 1992 2 DRAWN BY: P.M.R. CHECKED BY: M.L.S. H-4-40208 CADD FILE: 40208X08,DGN SUBMITTED BY: W. B. CONWAY MODJESKI & MASTERS Inc. SOLICITATION NO. DWG. 8 OF 16 DACW29-93-B-0025



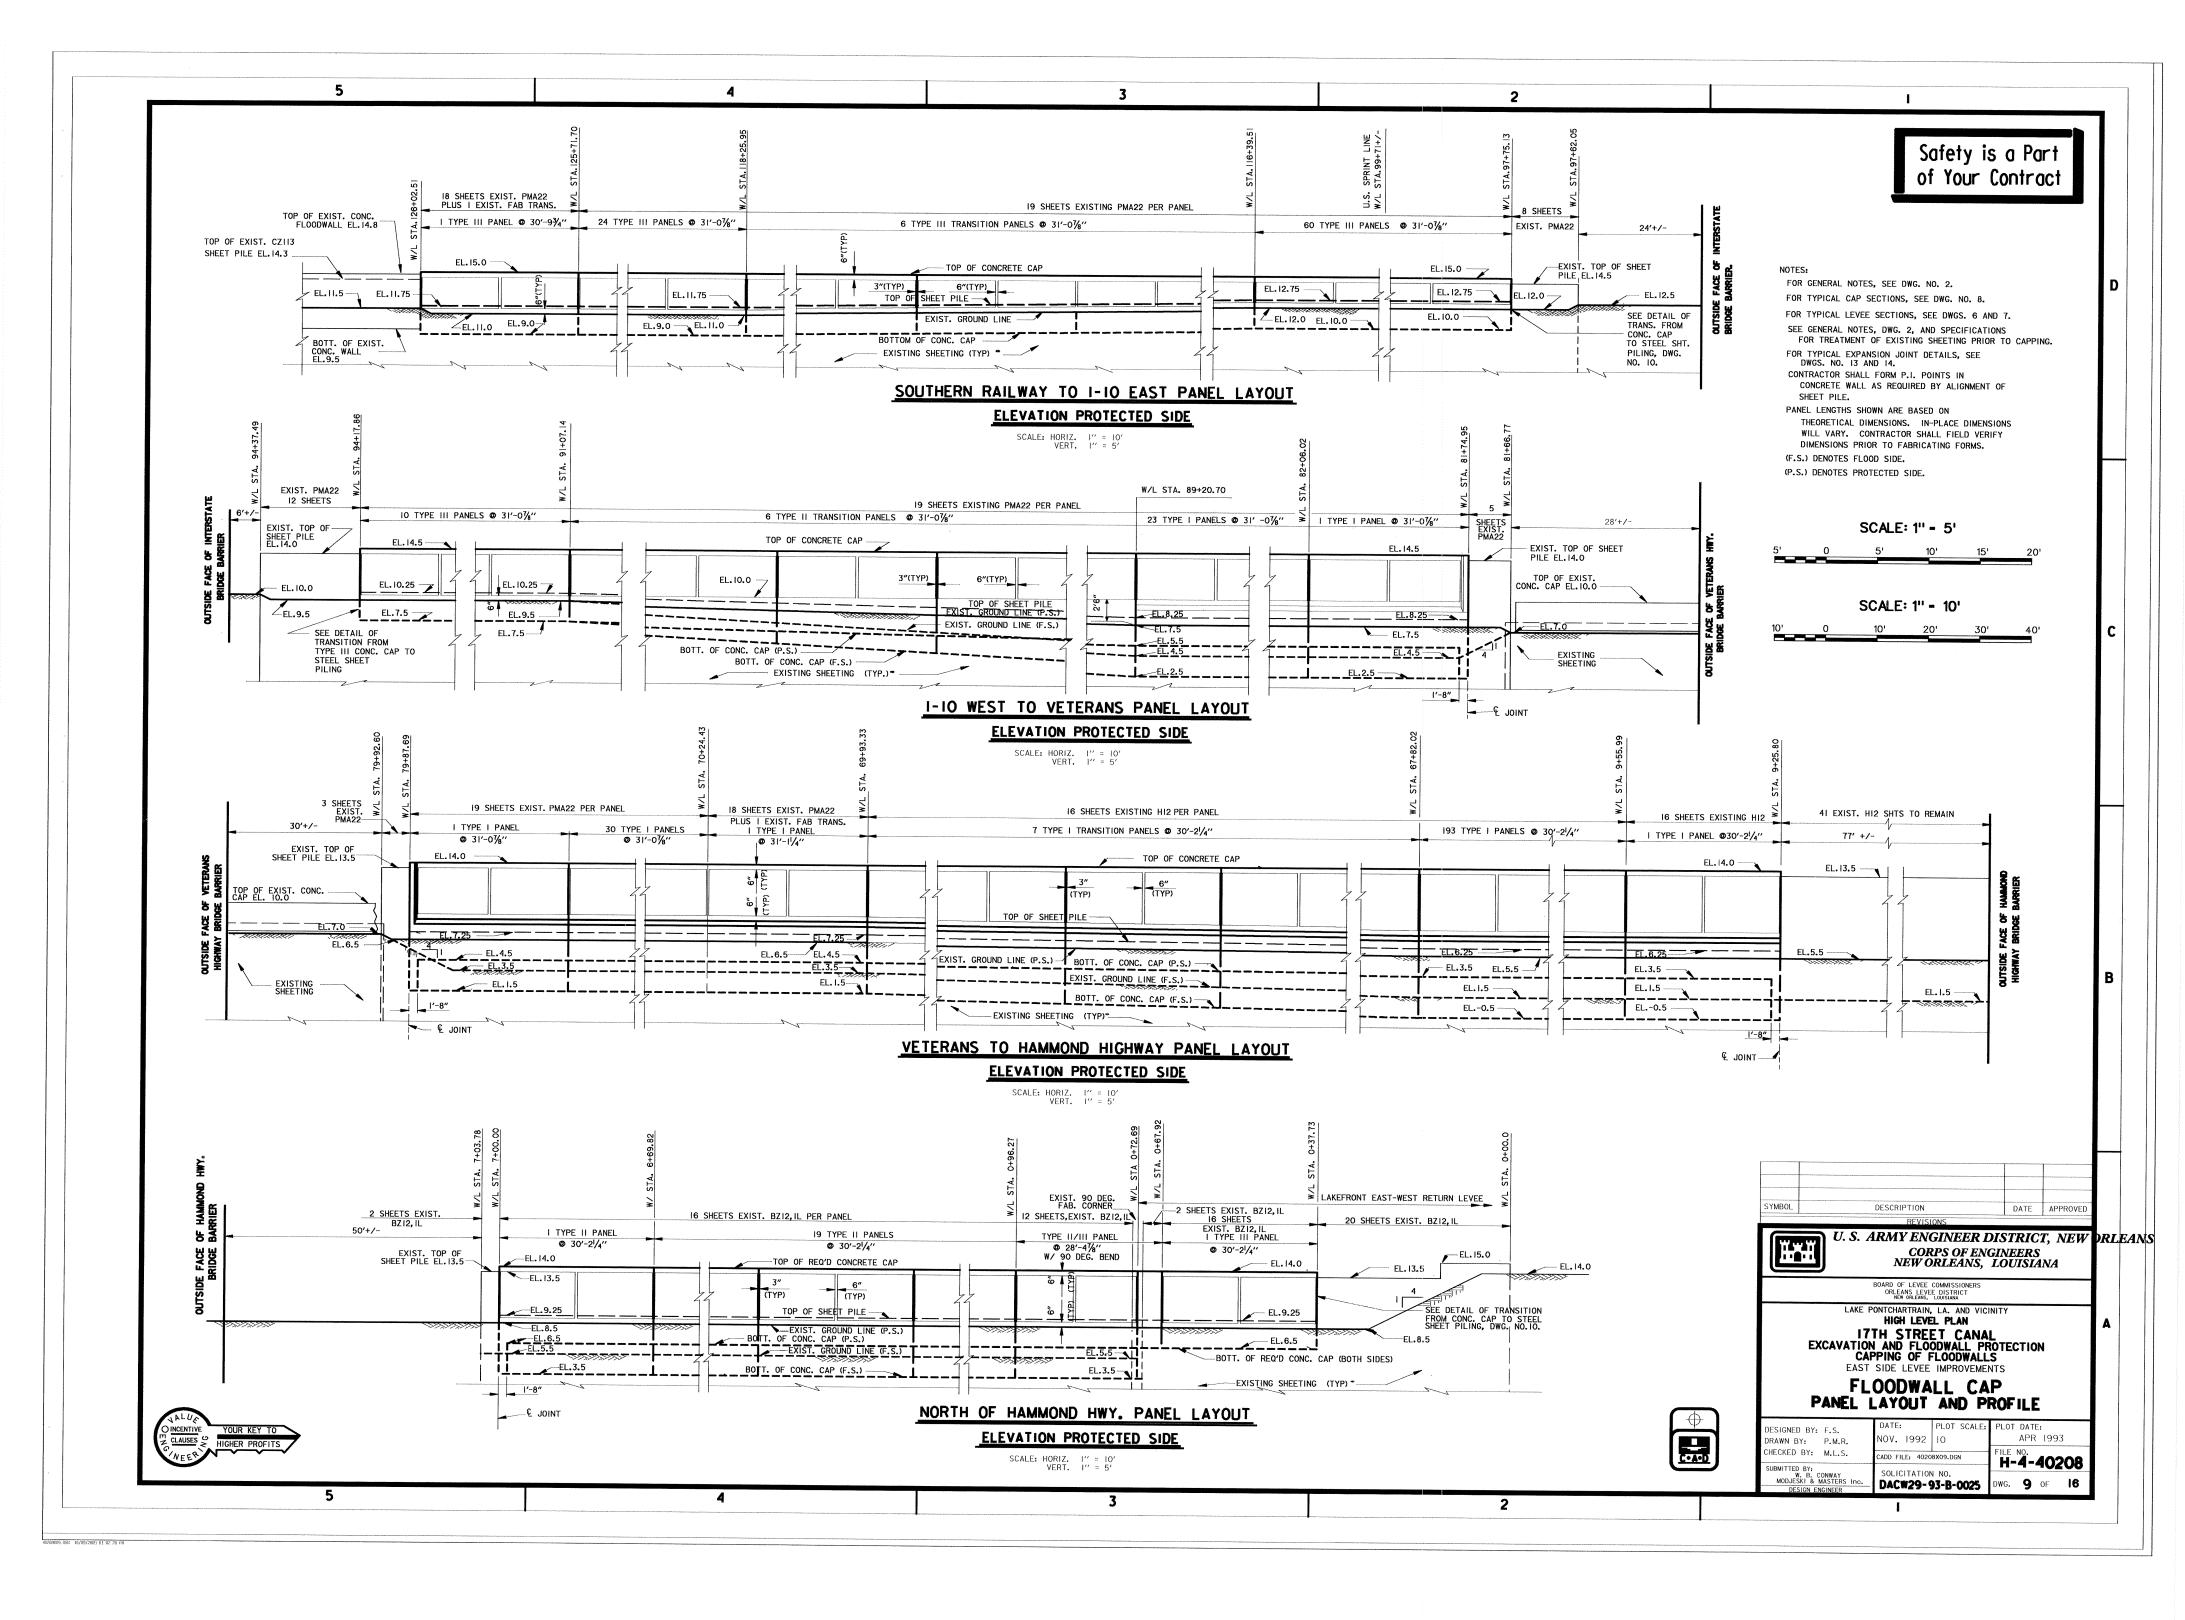

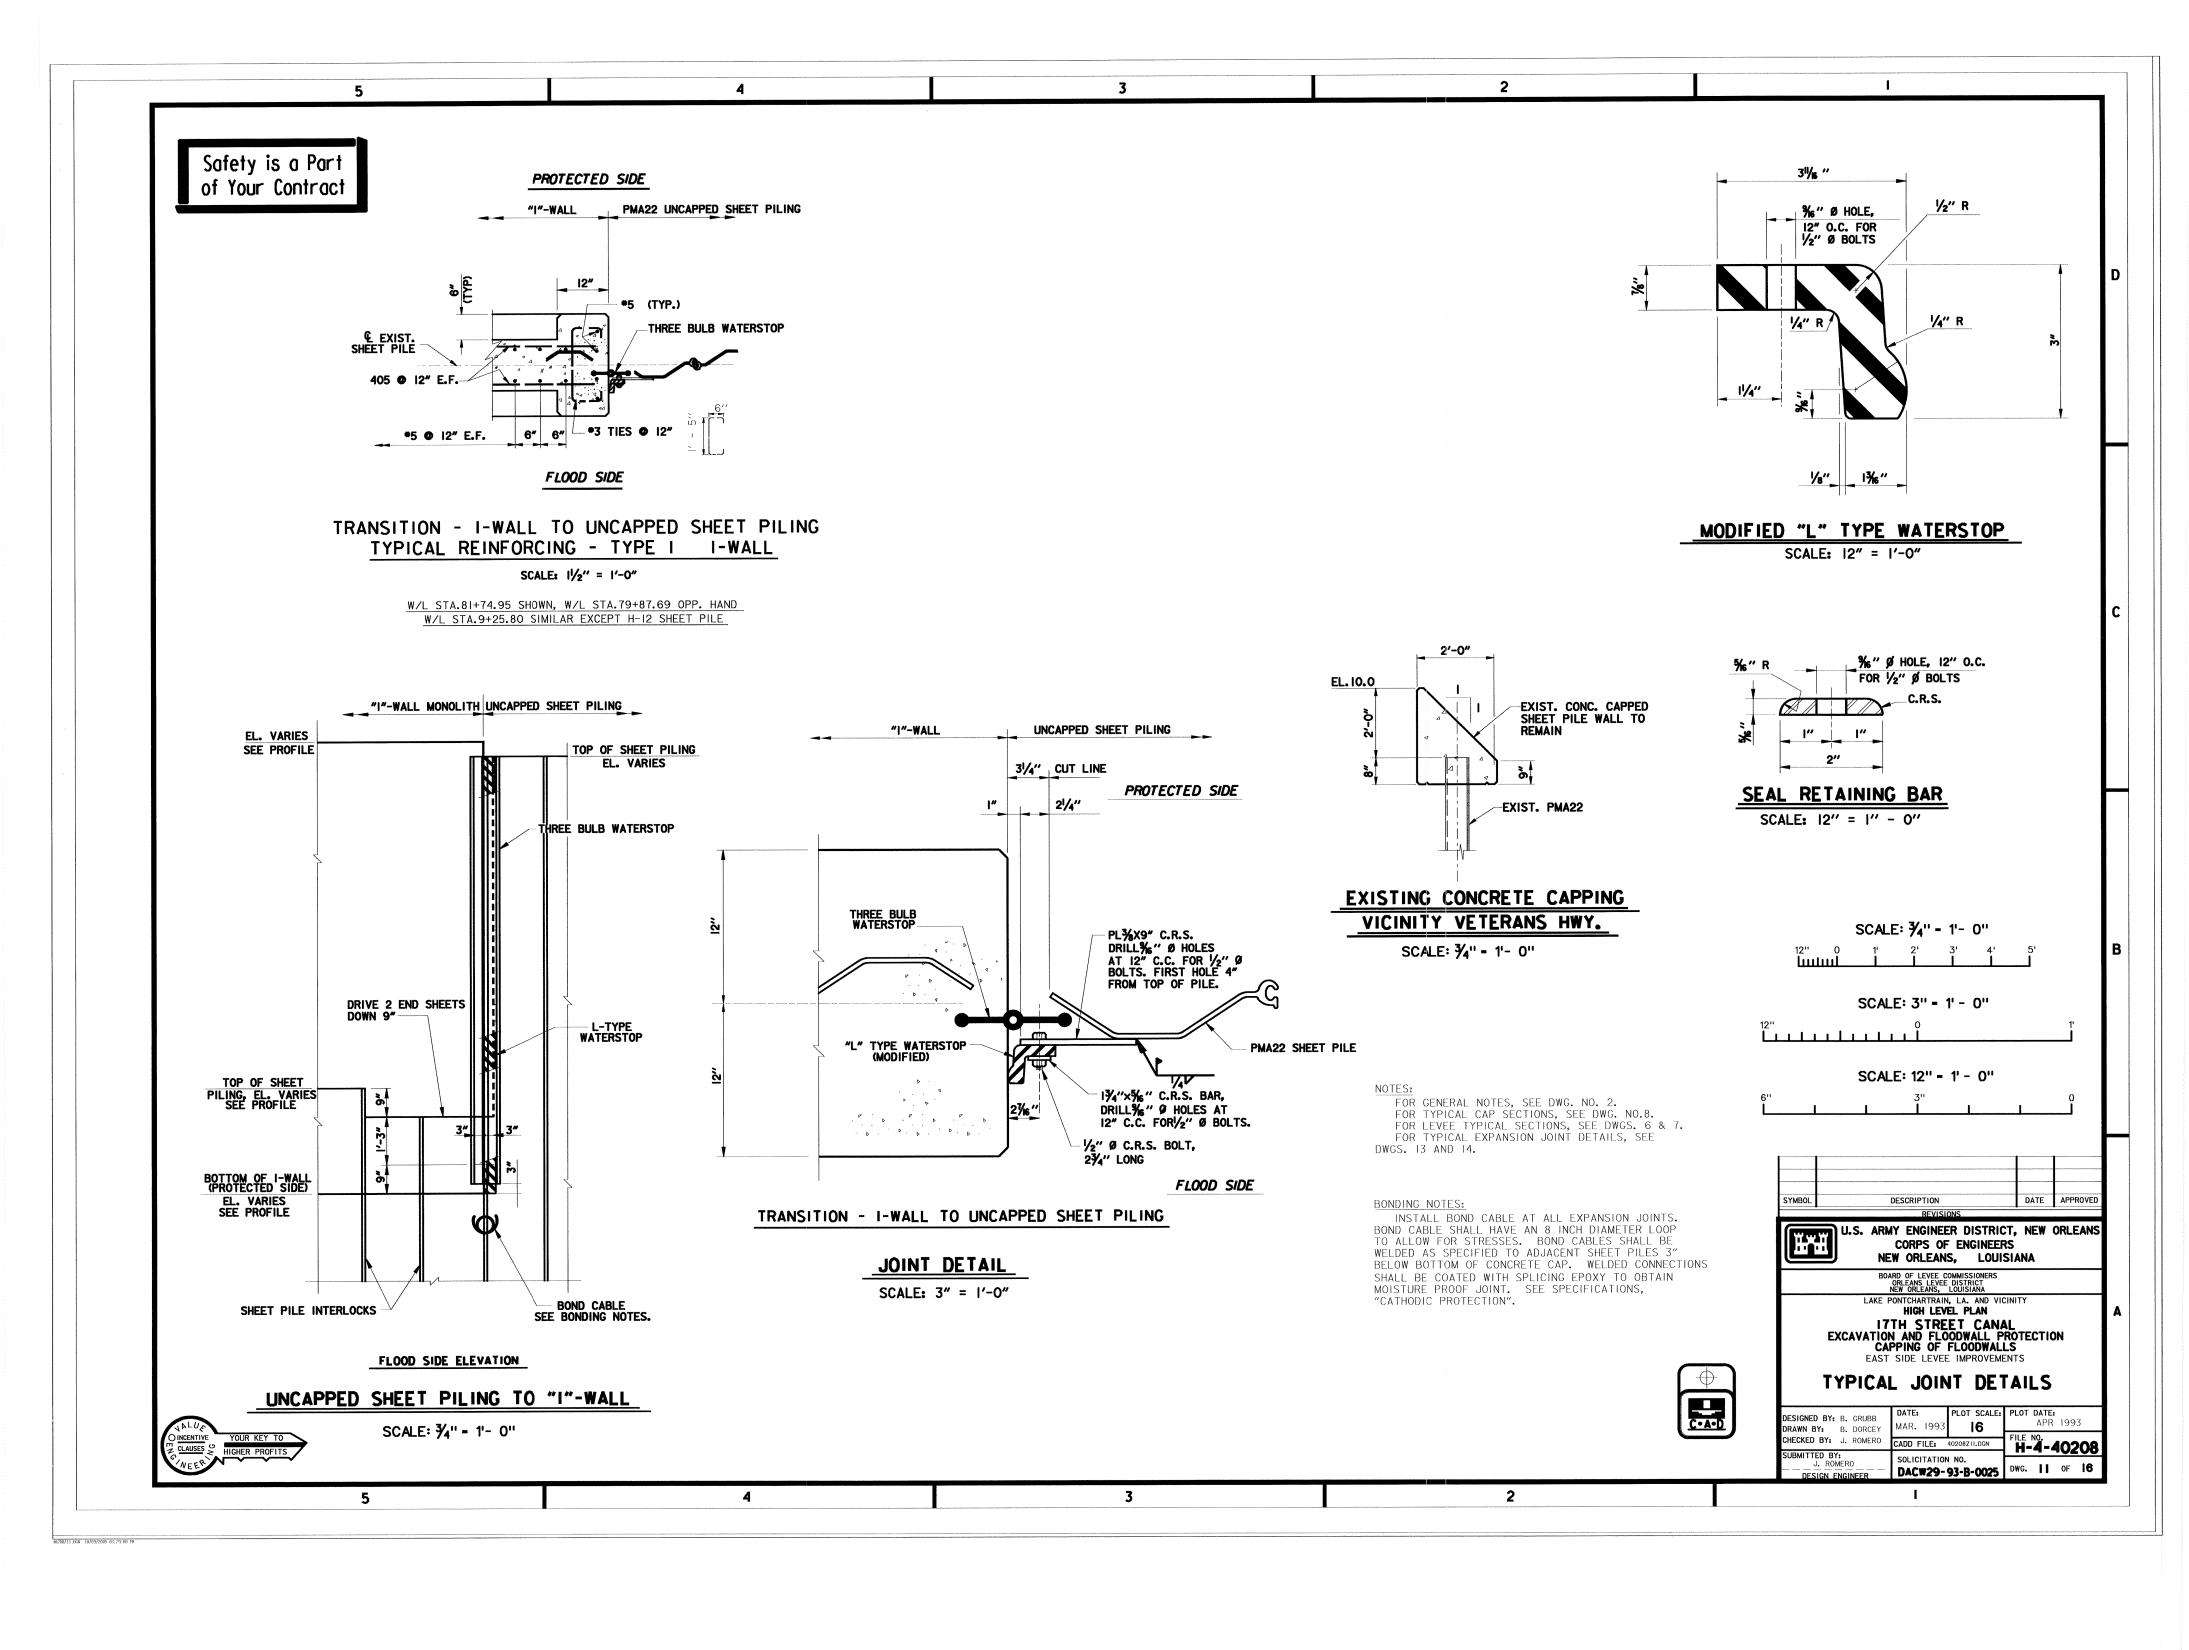

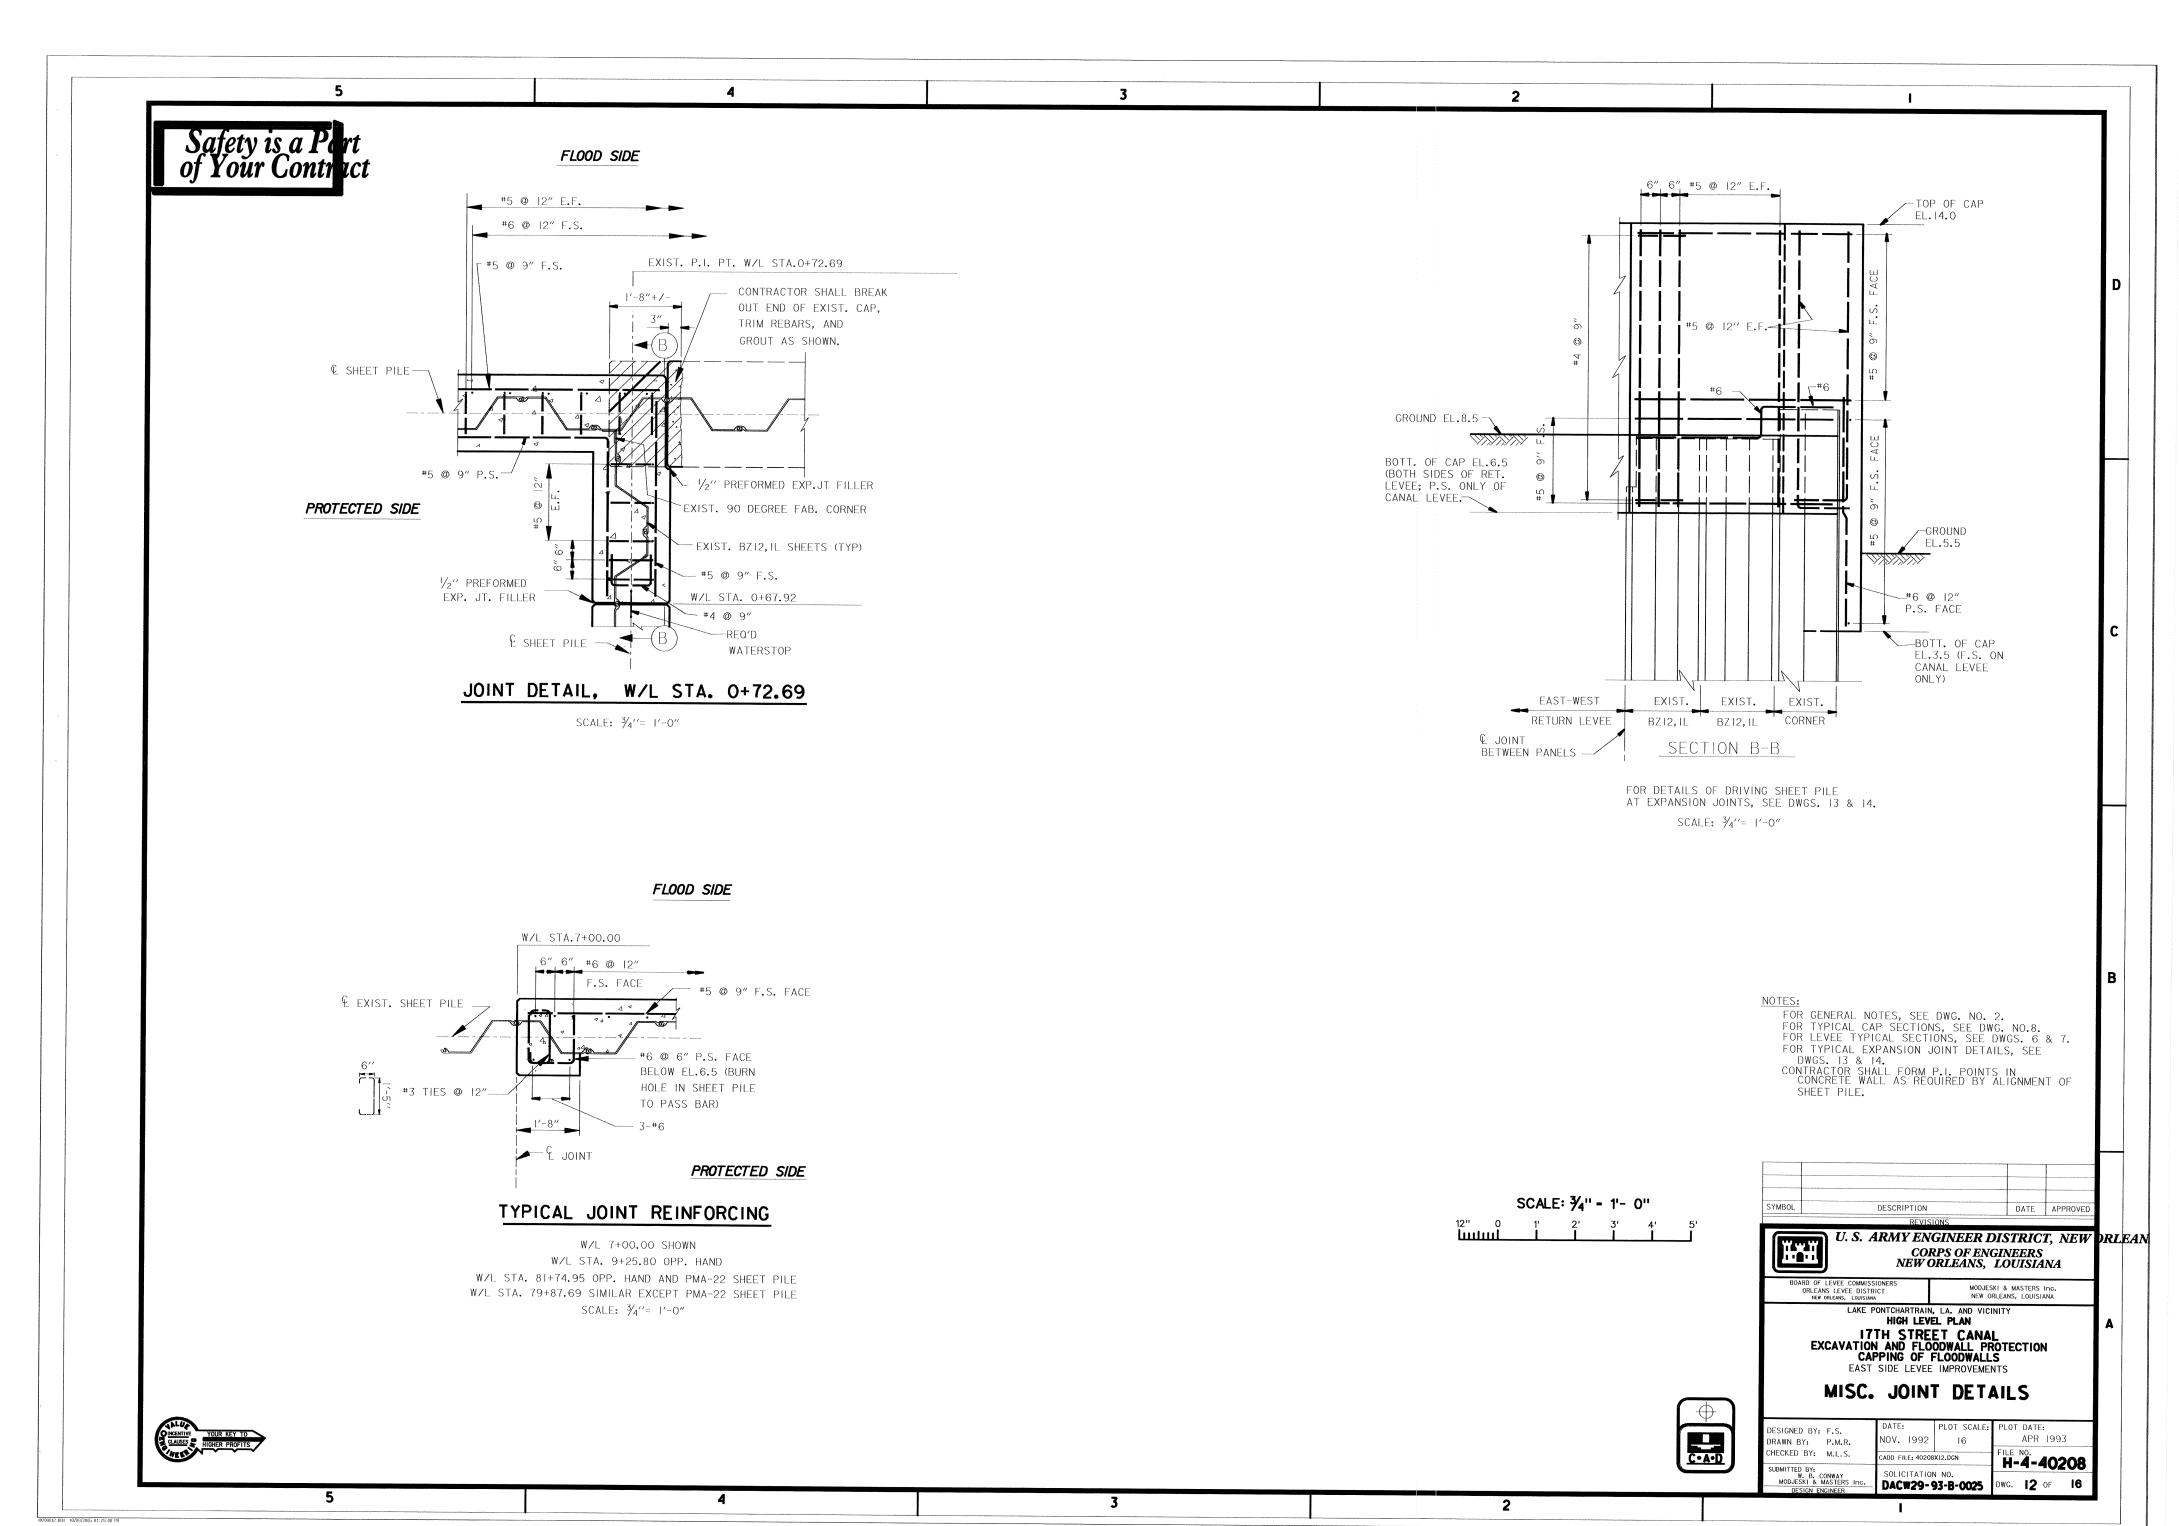

1/2" PREFORMED **EXPANSION JOINT**

¾" CHAMFER

4

D/2 ___ D/2

1/2" PREFORMED

C/L SHEET PILING

EXPANSION JOINT

3

EL. VARIES, SEE PROFILE

THREE BULB WATERSTOP

B

EL. VARIES, SEE PROFILE

D/2 D/2


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TYPICAL TYPE II AND III I-WALL JOINT

SCALE: 3/4" = 1'- 0"


| SE | TTLEMENT REFE MARKER SCHEDI | RENCE JLE |
|---------|--------------------------------|------------------|
| S.R.M. | | ELEVATION |
| NO. | (C/L MONOLITH JOINT |) * * |
| ı | 126+02.51 ** | * 11.33 |
| 2 TO 7 | 124+47.41 TO 118+25.95 | 11.33 |
| | (EVERY 124.29' OR 4 MONO | .) |
| 8 TO 17 | 116+39.51 TO 99+61.57 | 12.33 |
| | (EVERY 186.44' OR 6 MONO | .) |
| 18 | 97+75.13 ** | * 12.33 |
| 19 | 94+17.86 ** | * 9.83 |
| 20, 21 | 92+62.50 AND 91+07.14 | 9.83 |
| 22 | 89+20.70 | 8.25 |
| 22 - 26 | 89+20.70 TO 83+30.31 | 8.25 |
| | (EVERY 186.44' OR 6 MONO. | .) |
| 27 | 81+74.95 *** | * 8.25 |
| 28 | 79+87.69 *** | |
| 29 - 33 | 77+70.18 TO 70+24.43 | 7.25 |
| | (EVERY 186.44' OR 6 MONO. |) |
| 34- 65 | 67+82.02 TO 11+67.15 | 6.25 |
| | (EVERY 181.125' OR 6 MONO. | .) |
| 66 | 9+25.80 ** | ₭ 6.25 |
| 67 | 7+00.00 ** | ₩ 8.83 |
| 68 - 71 | 6+39.63 TO 0+96.27 | 8.83 |
| | (EVERY 181.125' OR 6 MONO. | |
| 72 | 0+37.73 *** | |
| | | |
| | | |

- * W/L STATIONS ARE APPROXIMATE. LOCATE REFERENCE BOLTS AT NEAREST W/L STATION TO THOSE SHOWN.
- ** NOTE: THE CONTRACTOR SHALL TAKE FINAL ELEVATIONS OF ALL SETTLEMENT REFERENCE MARKERS AND SHALL SUBMIT THIS DATA TO THE CONTRACTING OFFICER REPRESENTATIVE (COR). THE COR WILL FURNISH THIS DATA TO ENGINEERING DIVISION, ATTENTION OF: CELMN-ED-DD.
- *** ONLY ONE (I) SETTLEMENT REFERENCE MARKER REQUIRED

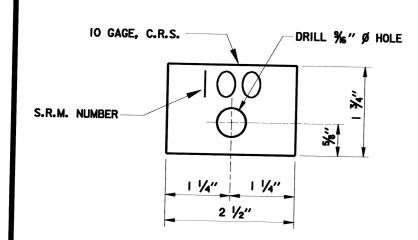

IDENTIFICATION TAG

SCALE: 12" = 1' - 0"

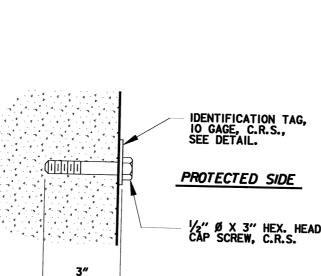


THREE BULB WATERSTOP,

SEE DETAIL

SECTION (B)

SCALE: 3" = 1' - 0"

REFERENCE BOLT SCALE: 6" = 1' - 0"

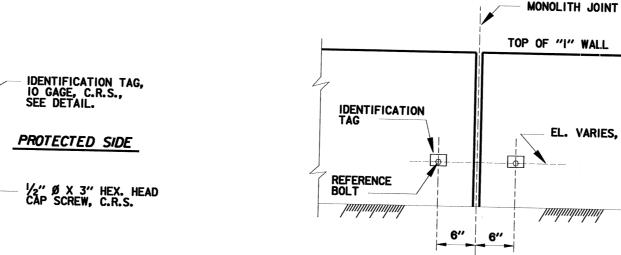


PROTECTED SIDE

TYPICAL ELEVATION OF SETTLEMENT REFERENCE MARKER

SCALE: 3/4" = 1'- 0"



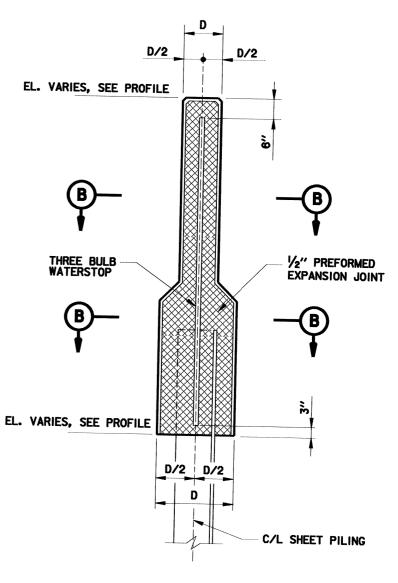

TYPICAL TYPE I I-WALL JOINT SCALE: 3/4" = 1'- 0"

> FOR GENERAL NOTES, SEE DWG. NO. 2. FOR TYPICAL CAP SECTIONS, SEE DWG. NO.8. FOR LEVEE TYPICAL SECTIONS, SEE DWGS. 6 & 7.
> CONTRACTOR SHALL FORM P.I. POINTS IN
> CONCRETE WALL AS REQUIRED BY ALIGNMENT OF

CONCRETE WALL AS REQUIRED BY ALIGNMENT OF SHEET PILE.

PANEL LENGTHS SHOWN ARE BASED ON THEORETICAL DIMENSIONS. IN-PLACE DIMENSIONS WILL VARY. CONTRACTOR SHALL FIELD VERIFY DIMENSIONS PRIOR TO FABRICATING FORMS.

DESCRIPTION DATE APPROVE

U. S. ARMY ENGINEER DISTRICT, NEW PRLEAN. CORPS OF ENGINEERS NEW ORLEANS, LOUISIANA BOARD OF LEVEE COMMISSIONERS ORLEANS LEVEE DISTRICT NEW ORLEANS, LOUISIANA


LAKE PONTCHARTRAIN, LA. AND VICINITY
HIGH LEVEL PLAN
17TH STREET CANAL
EXCAVATION AND FLOODWALL PROTECTION
CAPPING OF FLOODWALLS
EAST SIDE LEVEE IMPROVEMENTS


MISC. JOINT DETAILS

DESIGNED BY: R.J.G. DRAWN BY: R.J.G. NOV. 1992 16 CHECKED BY: R.J.G. CADD FILE: 40208A12.DGN H-4-40208 SOLICITATION NO. DACW29-93-B-0025 DWG. 13 OF 16

2

5

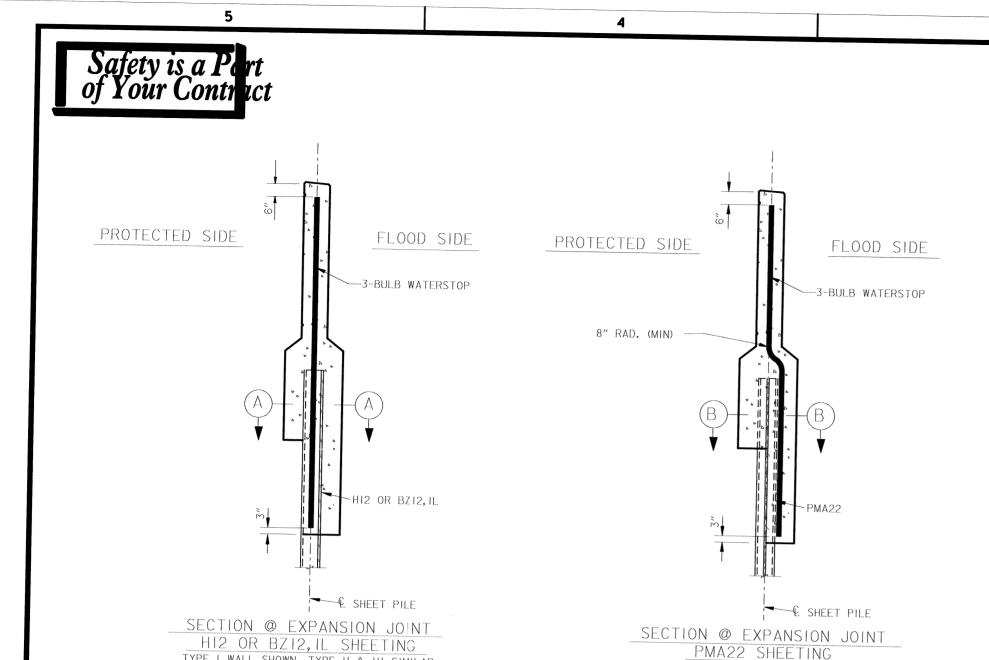

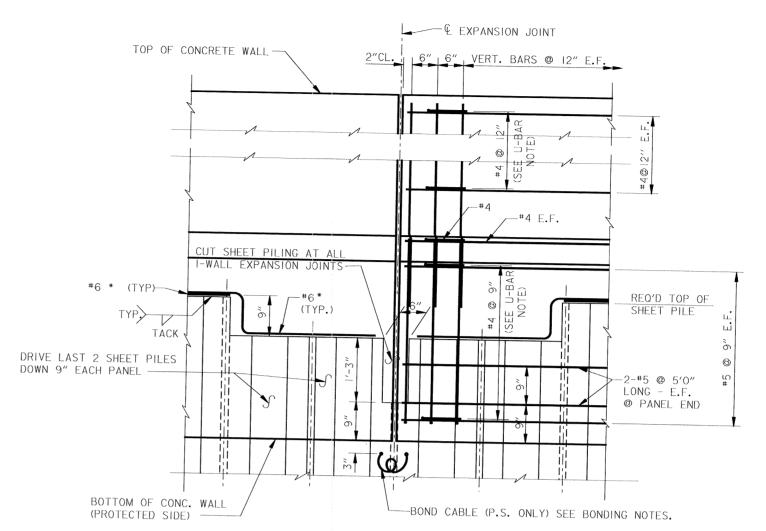


SHEET PILING AND REINFORCING DETAILS AT EXPANSION JOINTS

U-BAR NOTE (406,403):

#4 ONLY FOR TYPE I PANELS AS SHOWN. #4 SHALL BE USED AS SHOWN FOR TYPE I PANELS AND SHALL BE USED FOR TYPE II AND TYPE III PANELS FROM P.S. BOTTOM OF CONCRETE TO TOP OF CONCRETE. U-BARS SHALL NOT BE USED BELOW P.S. BOTTOM OF CONCRETE. *SHOWN FOR HI2 OR BZI2, IL. PMA22 SIMILAR EXCEPT TACK WELD LOCATED AT KNUCKLE. SEE BONDING NOTES.

#6 REINFORCING BAR TO BE WELDED TO THE TOP OF EACH STEEL SHEET PILE. #6 REINFORCING BAR SHALL NOT EXTEND ACROSS THE EXPANSION JOINT. INSTALL BOND CABLE AT ALL EXPANSION JOINTS.
BOND CABLE SHALL HAVE AN 8" DIAMETER LOOP TO ALLOW FOR STRESSES.
BOND CABLES SHALL BE WELDED AS SPECIFIED TO ADJACENT STEEL PILES 3" BELOW BOTTOM OF CONCRETE CAP.

WELDED CONNECTIONS SHALL BE COATED WITH SPLICING EPOXY TO OBTAIN MOISTURE PROOF JOINT. SEE SPECIFICATIONS "CATHODIC PROTECTION". #6 REINFORCING BARS SHALL BE WELDED TO THE LAST THREE SHEET PILINGS AT EACH END OF THE MONOLITH AS SHOWN FOR CONTINUITY. SPLICING OF #6 REINFORCING BAR WILL NOT BE ALLOWED.

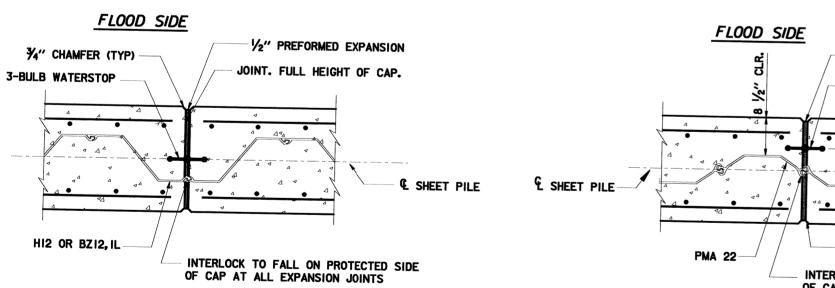


1/2" PREFORMED EXPANSION JOINT. FULL HEIGHT OF CAP. -3-BULB WATERSTOP ¾" CHAMFER (TYP) INTERLOCK TO FALL ON PROTECTED SIDE OF CAP AT ALL EXPANSION JOINTS

PROTECTED SIDE

TYPE I WALL SHOWN, TYPE II & III SIMILAR

SCALE: $\frac{1}{2}$ " = 1'-0"

SECTION SCALE: I"= I'-0"

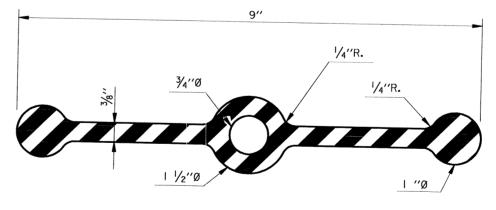

THREE BULB WATERSTOP SCALE: 12" = 1'-0"

FOR GENERAL NOTES, SEE DWG. NO. 2

U. S. ARMY ENGINEER DISTRICT, NEW DRLEANS HAH CORPS OF ENGINEERS NEW ORLEANS, LOUISIANA

MODJESKI & MASTERS INC NEW ORLEANS, LOUISIANA

LAKE PONTCHARTRAIN, LA. AND VICINITY
HIGH LEVEL PLAN I7TH STREET CANAL
EXCAVATION AND FLOODWALL PROTECTION
CAPPING OF FLOODWALLS
EAST SIDE LEVEE IMPROVEMENTS

FLOODWALL CAP MISC. JOINT DETAILS

ESIGNED BY: F.S. 10V. 1992 24 DRAWN BY: P.M.R. CHECKED BY: M.L.S. ADD FILE: 40208XI3.DGN SUBMITTED BY: W. B. CONWAY MODJESKI & MASTERS Inc.

APR 1993 H-4-40208 DWG. 14 OF 16

3

PROTECTED SIDE


5


SECTION

SCALE: I"= I'-0"

TYPE I WALL SHOWN, TYPE II & III SIMILAR SCALE: 1/2" = 1'-0"

SOLICITATION NO.
DACW29-93-B-0025

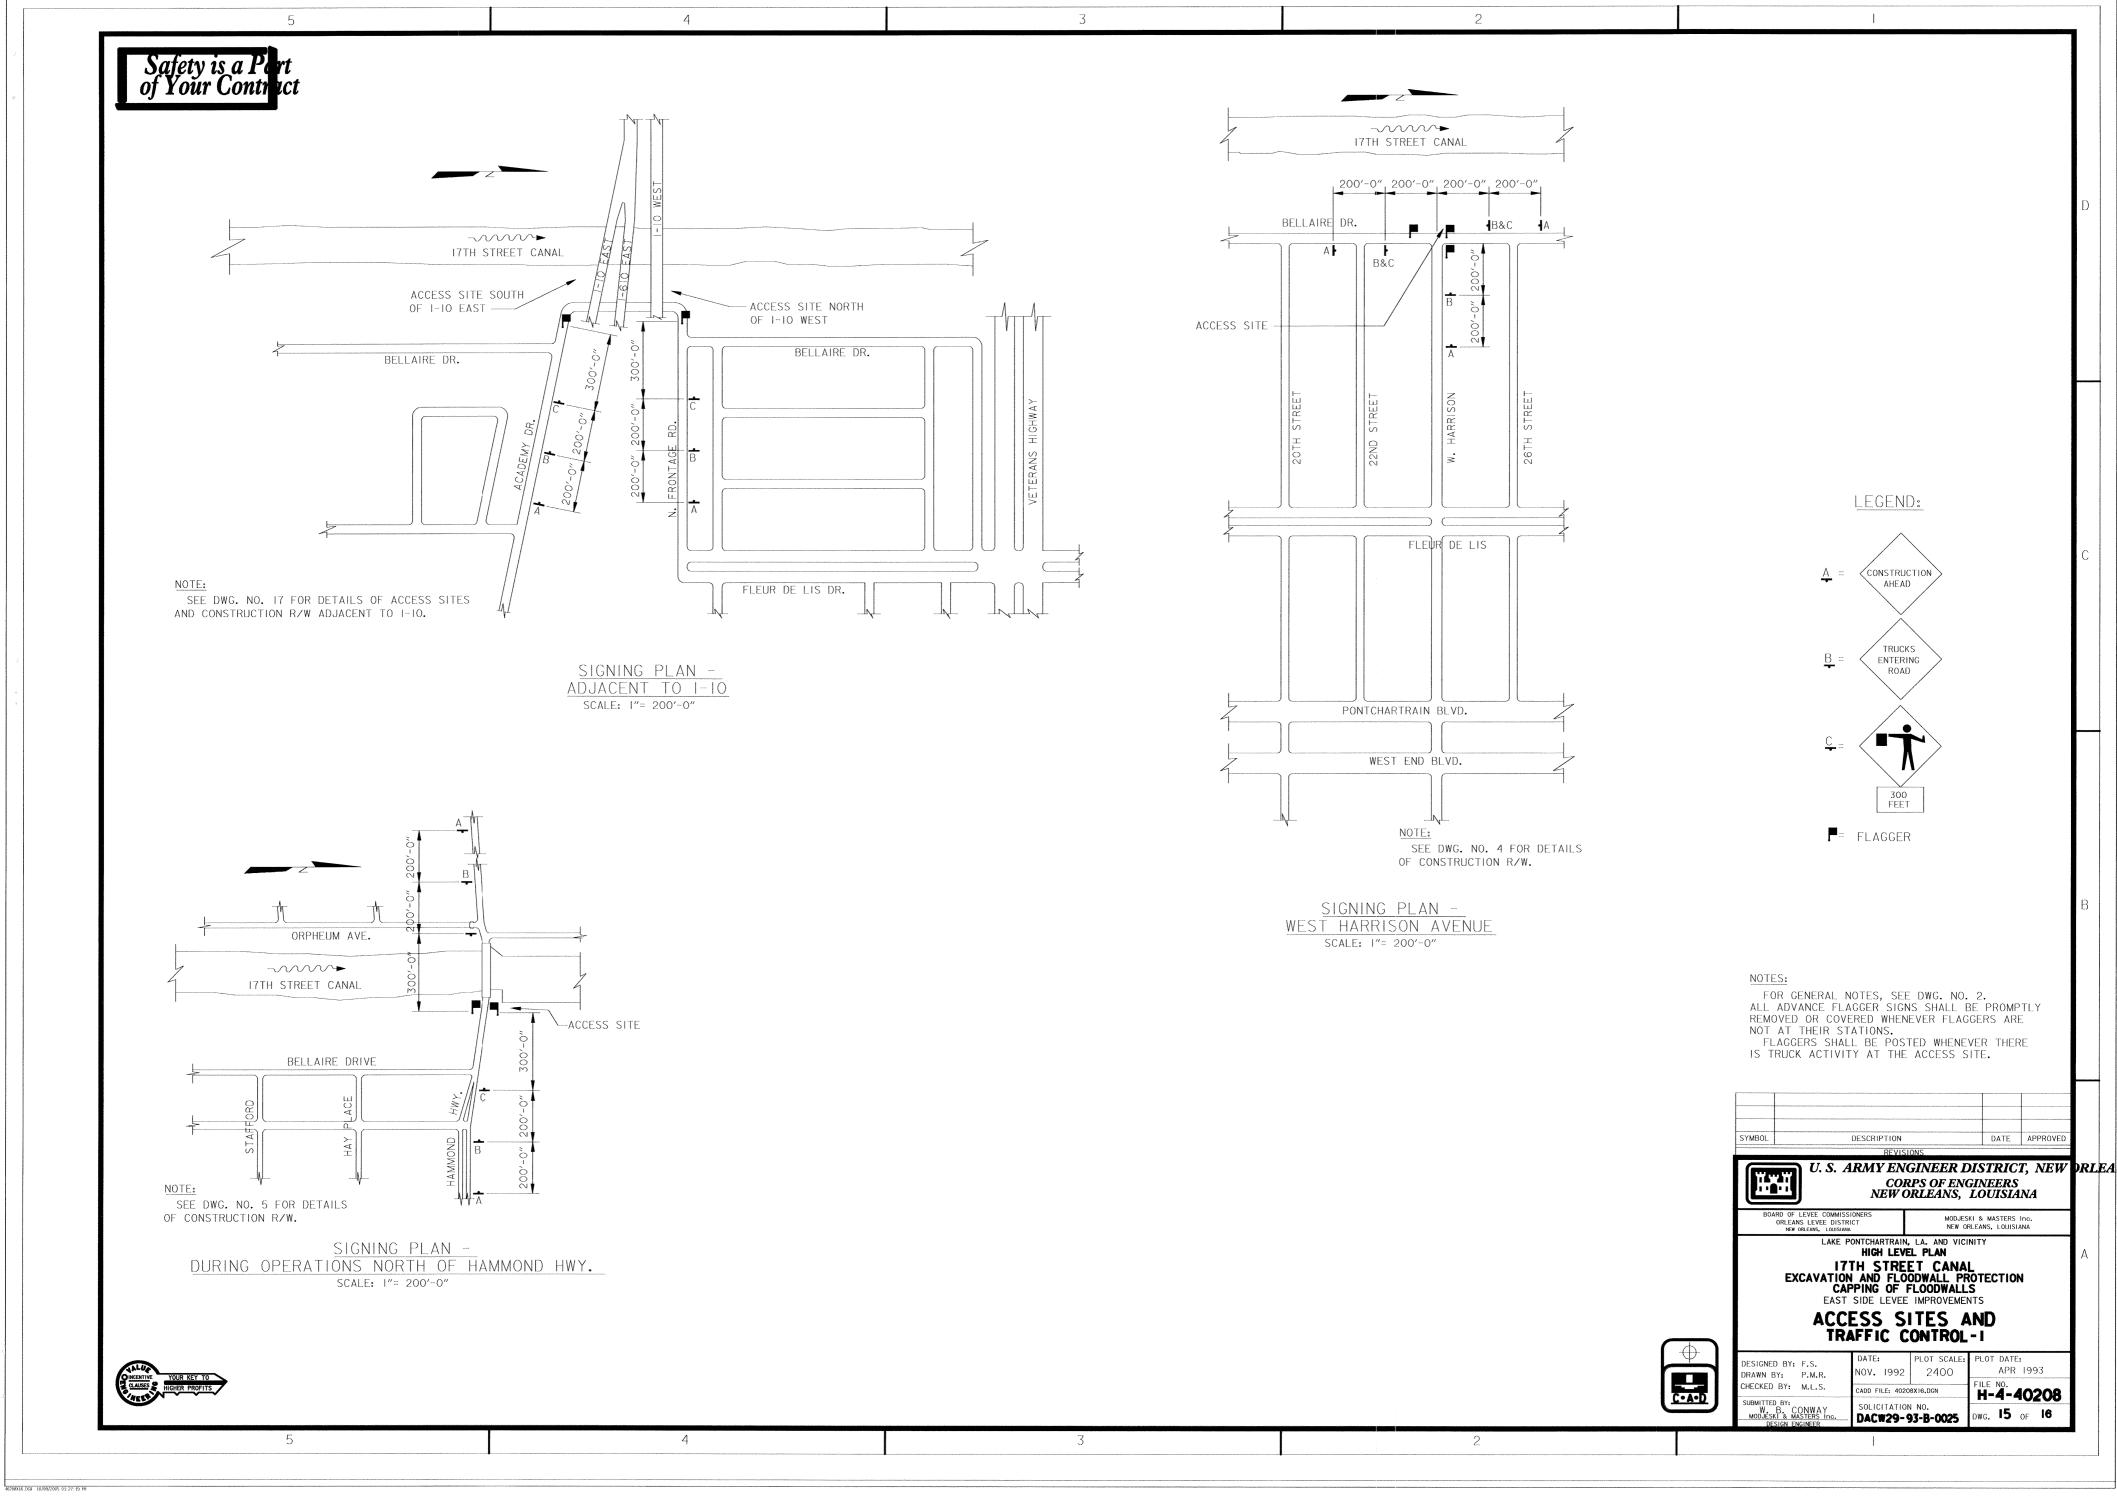

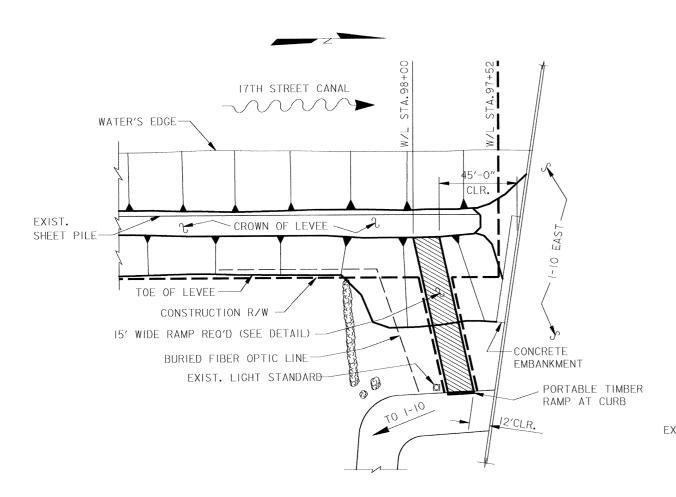


17TH STREET CANAL ~~~~~**>** -WATER'S EDGE CROWN OF LEVEE -EXIST. SHEET PILE CONSTRUCTION R/W -TOE OF LEVEE 15' WIDE RAMP REQ'D (SEE DETAIL) EMBANKMENT -EXIST. LIGHT STANDARD -PORTABLE TIMBER RAMP AT CURB

3

2

DETAILS - ACCESS SITE SOUTH OF 1-10 EAST SCALE: I"= 30'-0"

DETAILS - ACCESS SITE NORTH OF 1-10 WEST SCALE: I"= 30'-0"

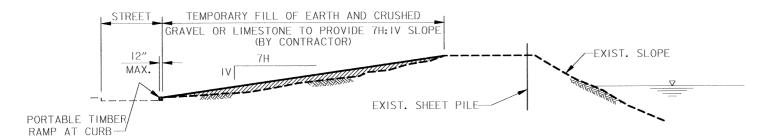

ACCESS RAMP DETAIL SCALE: I"= 20'-0"

RAMPS ADJACENT TO 1-10 SHOWN (STA.98+00 AND STA.94+04) RAMPS ADJACENT TO 1-10 SHOWN (STA.98+00 AND STA.94+04)
RAMP AT W.HARRISON AVE. LOT (STA.59+00) SIMILAR.
SEE SPECIAL CLAUSE "ACCESS AND TRUCKING REQUIREMENTS",
PART C, "ACCESS RAMPS".

FOR GENERAL NOTES, SEE DWG. NO. 2.

- 1

| | | | ŀ |
|--------|-------------|------|----------|
| | | | |
| | | | |
| SYMBOL | DESCRIPTION | DATE | APPROVED |

U. S. ARMY ENGINEER DISTRICT, NEW DRLEANS HAH CORPS OF ENGINEERS NEW ORLEANS, LOUISIANA

MODJESKI & MASTERS Inc. NEW ORLEANS, LOUISIANA LAKE PONTCHARTRAIN, LA. AND VICINITY
HIGH LEVEL PLAN

I7TH STREET CANAL
EXCAVATION AND FLOODWALL PROTECTION
CAPPING OF FLOODWALLS
EAST SIDE LEVEE IMPROVEMENTS

ACCESS SITES AND TRAFFIC CONTROL-2

| SUBMITTED BY: W. B. CONWAY MODJESKI & MASTERS Inc. DESIGN ENGINEER | SOLICITATION DACW29-9 | | DWG. | 16 of 16 |
|--|-----------------------|----------------|--------|-------------------|
| CHECKED BY: M.L.S. | CADD FILE: 4020 | 1 08X17.DGN | FILE N | 4-40208 |
| DESIGNED BY: F.S. DRAWN BY: P.M.R. | DATE: NOV. 1992 | PLOT SCALE: | | DATE: APR 1993 |

| AM | ENDMENT OF SOLICITATION/MC | DIFICATION OF CON | TRACT | 1. CONTRACT ID CO | DDE | PAGE OF PAGES |
|----------------|--|---|--|--|--|--------------------|
| 2. AM | ENDMENT/MODIFICATION NO. 0002 | 3. EFFECTIVE DATE 05/28/93 | 4. REQUISITION/PUI | RCHASE REQ. NO. -3336-0063 | 5. PROJECT NO dkn | D. (If applicable) |
| 6. ISS | UED BY COL | DE ISSUE1 | 7. ADMINISTERED I | BY (If other than Item 6) | CODE AL | DMIN1 |
| | | <u> </u> | | US ARMY ENGR DIST. | | |
| | US ARMY ENGR DIST NEW ORI | LEARS | | • | NEW UKLEANS | |
| | PO BOX 60267 | | | ATTN CELMN-CT | | |
| | NEW ORLEANS LA 70160-026 | 57 | | PO BOX 60267 | | |
| | | | | NEW ORLEANS LA 70 | 160-0267 | |
| | Molly M. Block | sc2 (504)862-2879 | | | | |
| 8. NA | ME AND ADDRESS OF CONTRACTOR (No., street, | county, State and ZIP Code) | | <u> </u> | ENT OF SOLICITATION OF SOLICIT | ON NO. |
| | | | | X 9B. DATED (SE | FEITEM 11) | |
| | | | | 04/21/93 | | |
| | | | | 10A. MODIFICA | ATION OF CONTRA | CT/ORDER NO. |
| | | | | 10B. DATED (S | SEE ITEM 13) | |
| COD | DE OMR68 | FACILITY CODE | · | | | |
| | | HIS ITEM ONLY APPLIES TO | AMENDMENTS OF | SOLICITATIONS | | |
| IXI TI | ne above numbered solicitation is amended | | | | is extended. □ i | s not extended. |
| IN R letter | IT TO BE RÉCÉIVED AT THE PLACE DESIGE EJECTION OF YOUR OFFER. If by virtue of the provided each telegram or letter makes recounting and appropriation data (if requirection) | of this amendment you desire ference to the solicitation an | e to change an offer al | ready submitted, such cha | ange may be ma | de by telegram or |
| | | APPLIES ONLY TO M | | | | |
| (X) | A. THIS CHANGE ORDER IS ISSUED PURSUANT | TO: (Specify authority) THE CH | ANGES SET FORTH IN IT | EM 14 ARE MADE IN THE COI | NTRACT ORDER N | D. IN ITEM 10A. |
| | B. THE ABOVE NUMBERED CONTRACT/ORDER SET FORTH IN ITEM 14, PURSUANT TO THE A | | E ADMINISTRATIVE CHA | NGES (such as changes in payi | ng office, appropria | tion date, etc.) |
| | C. THIS SUPPLEMENTAL AGREEMENT IS ENTE | RED INTO PURSUANT TO AUTHO | ORITY OF: | 1.1 1.11.11.11.11.11.11.11.11.11.11.11.1 | | · · |
| | D. OTHER (Specify type of modification and author | prity) | | | | |
| E. IN | APORTANT: Contractor is not, | is required to sign thi | is document and retur | n copies to the | issuing office. | |
| 14. D | ESCRIPTION OF AMENDMENT/MODIFICATION (O PLANS AND SPECIFICATIONS FOR L PROTECTION PROJECT, HIGH LEVEL PROTECTION IMPROVEMENT PROJECT IMPROVEMENTS, ORLEANS PARISH, | AKE PONTCHARTRAIN LA & V PLAN, 17TH ST. OUTFALL , CAPPING OF FLOODWALLS | VICINITY, HURRICANI CANAL, FLOOD , EAST SIDE | _ | nsi ble.) | |
| | BID OPENING DATE AND TIME OF 2 OPEN ON 9 JUNE 1993, 2:00 P.M. | • | | | | |
| | pt as provided herein, all terms and conditions of the NAME AND TITLE OF SIGNER (Type or print) | document referenced in Item 9A | | iged, remains unchanged and in TLE OF CONTRACTING OFFIC | | et |
| 15B | CONTRACTOR/OFFEROR | 15C. DATE SIGNED | 16B. UNITED STAT | ES OF AMERICA | | 16C. DATE SIGNED |
| | | | | | | |
| - | (Signature of person authorized to sign) | | BY (Signatu | re of Contracting Officer) | | |

BID SCHEDULE

Delete page B-1 in its entirety and substitute the attached revised page B-1 therefor.

SECTION C

- (1) Page C2A-3, paragraph C2A-7(5). Delete the first four lines in their entirety and substitute "The Contracting Officer will require frequent use of" therefor.
- (2) Page C2C-4, paragraph C2C-4.9. Delete the last line in its entirety and substitute the following therefor.

"Government and to the Louisiana Department of Environmental Quality (LADEQ). Proof of acceptance and conditions and said acceptance shall be submitted to the Contracting Officer prior to the removal of any muck from the job site. Any required permits for the disposal shall be obtained by the Contractor at his expense. The LADEQ point of contact is Mr. Gerald Mathes, (504)-765-0249."

- (3) Page C2E-1, paragraph C2E-1. In the 4th line add "and" between "grade," and "constructing". Starting in the 7th line and ending in the 8th line, delete "and removing coal tar epoxy paint from the sheet pile".
- (4) Page C2E-2, paragraphs C2E-2.6 and C2E-3.3. Delete these paragraphs in their entirety and substitute "C2E-2.6 Reserved." and "C2E-3.3 Reserved." therefor respectively.
- (5) Page C2E-3, paragraph C2E-3.6(1). In the first line, after the word "installation" add ", removal".

(6) Page C2E-4.

- a. Subparagragh C2E-4.1(6). Delete this paragraph in its entirety and substitute "(6) Removal of existing coal tar epoxy paint where stud anchors are placed."
- b. Paragraph C2E-5.1. Delete the 3rd and 4th lines in their entirety and substitute "to be capped only where welded steel studs will be placed."
- c. Paragraph C2E-5.3.2.3. In the 2nd line, change "surface o t the" to "surface of the".

(7) Page C2E-17.

a. Paragraph C2E-10.1. Add "The Contractor shall remove the cofferdam after the floodwall construction is complete within the above stations." to the end of the paragraph.

- b. Paragraph C2E-11. In the 2nd line, add "and removal" between the words "construction" and "of".
- (8) Page C2E-18, paragraph C2E-12.3. In the first line after the word "constructing", add "and removing". In the second line after the word "construction", add "and removal".
- (9) Page C3D-22, paragraph C3D-12.2.2. In the 4th line from the end of the paragraph, change "the protected side" to "both sides".
- (10) Add the attached new Section C5B, pages C5B-a, C5B-1, C5B-2, and C5B-3.

SECTION H

- (1) Page H-28, sub-paragraph H-28.a.1. Change "Hammond Highway" to "Lake Marina Drive" and "vice-versa" to "Hammond Highway".
- (2) Page H-28, sub-paragraph H-28.a.2. Delete this paragraph in its entirety and substitute the following therefor:
- "2. South of Hammond Highway. Trucks leaving this access site shall exit onto Hammond Highway and travel designated truck routes to their destination and enter at the intersection of West Harrison and Bellaire Drive."
- (3) Page H-29, sub-paragraph H-28.a.5.b. In the 2nd sentence, change "H-9(f)" to "H-9(g)". In the 3rd sentence, delete "15 feet", and add "as shown on the drawings" after the words "sheet pile".
- (4) Page H-31, paragraph H-30. In the 7th typed line from the end of the paragraph, change "siste" to "site".
- (5) Add the following new clause to the end of the Special Clauses.

"H-34 ORDER OF WORK. The Contractor shall not proceed with work between Hammond Highway and West Harrison Blvd. until all other construction activities have been completed (East Jefferson Levee District, Contract 92-1) between these streets."

DRAWINGS

Delete Dwgs. 2, 5, 8, 9, and 15 of 17, File No. H-4-40208, in their entirety and substitute the attached revised Dwgs. 2, 5, 8, 9, and 15 of 17, File No. H-4-40208 therefor.

SOLICITATION DACW29-B-0025 AMENDMENT 0002 PAGE 4 OF 8

SOLICITATION NO. DACW29-BIDDING SCHEDULE

(To be attached to Bid Form)

LAKE PONTCHARTRAIN LA. & VICINITY, HURRICANE PROTECTION PROJECT, HIGH LEVEL PLAN, 17TH ST. OUTFALL CANAL, FLOOD PROTECTION IMPROVEMENT PROJECT, CAPPING OF FLOODWALLS, EAST SIDE IMPROVEMENTS, ORLEANS PARISH, LA

| Item No. | Description | Estimated Quantity | Unit | Unit Price | Est. Amt. |
|-------------|--|-----------------------|----------|---------------|--------------|
| 0001. | Mobilization and Demobilization | Lump Sum | LS | | |
| 0002. | Clearing | Lump Sum | LS | | |
| 0003. | Structural Excavation and Backfill | Lump Sum | LS | | |
| 0004. | Fertilizing, Seeding and Mulching | Lump Sum | LS | | |
| 0005. | Driving Existing Sheet Piles in Place | Lump Sum | LS | | |
| 0006. | Reinforced Concrete Cap | Lump Sum | LS | | |
| 0007A | Erosion Control A. First 11,600 LF B. All Over 11,600 LF | 11,600 2,300 | LF LF | | |
| 0008. | Cofferdam | Lump Sum | LS | | |
| | TOTAL | | | <u> </u> | |

Award will be made as a whole to one bidder.

NOTE: Bidders shall furnish unit prices for all items listed on schedule of bid items which require unit prices. If the bidder fails to insert a unit price in the appropriate blank for required items but does furnish an extended total or an estimated amount for such items, the Government will deem his unit price to be the quotient obtained by dividing the extended estimated amount for that line item by the quantity. IF THE BIDDER OMITS BOTH THE UNIT PRICE AND THE EXTENDED ESTIMATED AMOUNT FOR ANY REQUIRED ITEM, HIS BID WILL BE DECLARED NON-RESPONSIVE. Quantities shown on Bid Item 0007 are for evaluation purposes. Payment for these items will be made on the basis of actual quantities used.

INDEX SECTION C5B - MISCELLANEOUS METALWORK

| Para. No. | Paragraph Title | Page No. |
|--------------|-----------------------------------|-------------|
| | | |
| C5B-1. | SCOPE | C5B-1 |
| C5B-2. | QUALITY CONTROL | C5B-1 |
| C5B-3. | SUBMITTALS | C5B-1 |
| C5B-4. | FABRICATED AND MANUFACTURED ITEMS | C5B-2 |
| C5B-5. | WORKMANSHIP | C5B-3 |
| C5B-6. | MEASUREMENT AND PAYMENT | C5B-3 |

SECTION C5B - MISCELLANEOUS METALWORK PART 1 - GENERAL

- C5B-1. SCOPE. The work covered by this section consists of furnishing all plant, labor, materials and equipment, and furnishing and installing the miscellaneous metalwork as shown on the drawings and specified herein and shall include, but is not limited to, the following items:
 - C5B-1.1 Corrosion Resistant Steel (C.R.S.).
 - C5B-1.1.1 Settlement reference bolts.
 - C5B-1.1.2 Identification tag for reference bolts.
 - C5B-1.2 Manufactured Products.
- C5B-1.2.1 Flexible bonding jumpers for bonding of piling as specified in Section C16A.
 - C5B-1.2.2 Plastic sealant as specified herein.
 - C5B-1.3 Fabricated Steel.
 - C5B-1.3.1 Slip joint, Capped I-wall to Uncapped I-wall.
 - C5B-2. QUALITY CONTROL.
- C5B-2.1 <u>General</u>. The Contractor shall establish and maintain quality control for proper fabrication and installation of all work covered in this section to assure compliance with contract specifications and maintain records of his quality control for all construction operations including but not limited to the following:
 - (1) Fabrication.
 - (2) Protective coating.
 - (3) Placement and protection.
 - (4) Material compliance with plans and specifications.
- C5B-2.2 <u>Reporting</u>. The original and two copies of these records and tests, as well as the records of corrective action taken, shall be furnished to the Government daily. Format of the report shall be as prescribed in the Special Clause entitled "CONTRACTOR QUALITY CONTROL".
 - C5B-3. SUBMITTALS.
- C5B-3.1 <u>Shop Drawings</u>. The Contractor shall prepare and submit for approval, complete shop drawings and descriptive literature showing details of all auxiliary items required as

indicated herein or on the contract drawings. Shop drawings shall indicate computed weights of structural steel and approval of shop drawings will constitute acceptance of the computed weights shown on these drawings.

C5B-3.2 <u>Manufacturer's Certification</u>. The galvanizing compound shall be certified for compliance with all specification requirements.

PART 2 - PRODUCTS

- C5B-4. FABRICATED AND MANUFACTURED ITEMS.
- C5B-4.1 <u>General</u>. Fabrication and placement of all fabricated items shall be as indicated on the drawings.
 - C5B-4.2 Materials.
- C5B-4.2.1 Corrosion Resistant Steel. Corrosion resistant steel shall conform to Federal Specification QQ-S-766C (up to and including amendment 6), Class 304. High strength corrosion resistant steel shall conform to ASTM A 276-84, Type 431. Corrosion resistant steel bolts, nuts and washers shall conform to the applicable provisions of C5B-12 except that the material shall be corrosion-resistant steel.
- C5B-4.2.2 <u>Plastic Sealant</u>. This sealant shall conform to the applicable provisions of Federal Specification SS-S-00210 "Sealing Compound, Preformed Plastic, for Expansion Joints and Pipe Joints".
- C5B-4.2.3 Transition from Capped I-Wall to Uncapped I-Wall. The steel sheet piling slip joint shall be surrounded by 18 gage steel sheet metal, as shown on the drawings. The space between the sheet metal and the steel sheet piling is to be filled with a plastic sealant.
- C5B-4.3 <u>Galvanizing</u>. Hot-dip galvanizing or zinc coating applied on products fabricated from rolled, pressed, or forged steel shapes, plates, bars, and strips shall comply with ASTM A 123. Hot-dip galvanizing or zinc coatings on assembled steel products shall comply with ASTM A 386. Weight of coatings shall be as designated in Table 1 of the ASTM specification for class and thickness of material to be coated, but in no case shall it be less than 1.25 oz. per square foot.
- C5B-4.4 <u>Expansion Anchors</u>. Fed. Spec. FF-S-325, Group II, Type 4, Class 1. Nail driven types will not be acceptable. Anchors shall be galvanized unless otherwise indicated.

PART 3 - EXECUTION

C5B-5. WORKMANSHIP. All parts shall be properly fabricated, assembled and installed to conform to the shapes, sizes and dimensions indicated on the contract drawings and approved shop drawings.

C5B-5.1 <u>Settlement Reference Bolts</u>. Upon installation of the settlement reference bolts the Contractor shall determine elevations of each bolt and submit his results to the Contracting Officer.

C5B-6. MEASUREMENT AND PAYMENT.

C5B-6.1 Unless otherwise specified herein, any materials or operations used in conjunction with installation or as part of metalwork which is not included in the cost of other items of work listed in the bidding schedule shall not be measured for payment. Payment for miscellaneous metalwork will be included in the contract lump sum price for "Reinforced Concrete Cap". This price and payment shall constitute full compensation for furnishing and installing all miscellaneous metalwork indicated on the drawings and/or herein specified which is not specified to be paid for under other items of work listed on the bidding schedule.

GENERAL NOTES: Safety is a Part 6. THE CONTRACTOR SHALL NOTE THE CLOSE PROXIMITY OF RESIDENCES, TREES, AND UTILITIES ALONG THE ENTIRE LENGTH OF THE PROJECT SITE. HE SHALL EXERCISE EXTREME CAUTION AT ALL TIMES WHEN WORKING ON THE I. ALL REFERENCES TO WALL LINE (W/L) REFER of Your Contract TO THE CENTERLINE OF THE EXISTING SHEET PILE WALL ON THE ORLEANS LEVEE OF THE 17TH STREET CANAL. STATIONING ALONG THE WALL IS BASED ON THE THEORETICAL WIDTH OF THE SHEETS (BZ12.IL AND HOESCH 12 OBSTRUCTIONS TO R/W LEVEE AND HE SHALL BE RESPONSIBLE FOR THE REPAIR OF ANY DAMAGE RESULTING FROM W/L STATION (APPROXIMATE DISPOSITION ARE 22.64"; PMA-22 IS 19.625") ITEM AND OWNER HIS OPERATIONS. 2. ELEVATIONS REFER TO NATIONAL GEODETIC U.S. SPRINT FIBER OPTIC LINE DWG. NO. 2 99+71 VERTICAL DATUM (N.G.V.D.). ELEVATION AT U.S.C.E. MONUMENT 14 IS 8.77 N.G.V.D.. DWG. NO. 4 35+82 L.P.& L. POWER LINE 7. CONTRACTOR SHALL PROVIDE, ERECT, AND MAINTAIN A SAFETY FENCE AROUND THE CONSTRUCTION RIGHT-OF-WAY. SEE SPECIAL CLAUSE "SAFETY 3. NORMAL WATER SURFACE ELEVATION RANGE IS FROM EL.1.5 TO EL.2.0 (N.G.V.D.).. PROVISIONS". 4. REFERENCES TO THE PROTECTED SIDE OF THE LEVEE REFER TO THE LAND SIDE OF THE LEVEE. REFERENCES TO THE FLOOD SIDE OF THE LEVEE REFER TO THE CANAL OR LAKE SIDE OF THE LEVEE. 8. SEE DRAWING 5 FOR BENCH MARK INFORMATION. 5. THE CONTRACTOR SHALL WELD % IN. BY 8 IN. STUD ANCHORS ON THE EXISTING SHEET PILE AS INDICATED AND SPECIFIED IN THE SPECIFICATIONS. 17TH STREET CANAL FLOW END EXIST. SHEET PILE W/L STA.97+62.05 FLOOD SIDE CONSTRUCTION R/W END CONCRETE CAP W/L STA.97+75.13 -P.I. W/L STA.125+83.14 CONSTRUCTION R/W -BURIED U.S. SPRINT FIBER
OPTIC LINE W/L 99+71+/(SEE DWG. NO. 10 FOR DETAILS)— P.I. W/L STA.112+24.11 P.I. W/L STA.118+27.58 REO'D SAFETY FENCE WITH EROSION CONTROL-(PROTECTED SIDE ONLY, SEE SECTION BELOW) & EXIST. & NEW FLOODWALL ---PROTECTED SIDE -BEGIN CONCRETE CAP W/L STA. 126+02.5 ACCESS SITE (SEE DWG. NOS.15 & 16 FOR DETAILS) L-PUMPING STA. NO.6. BELLAIRE DR. PLAN SCALE I"= 100'-0" DEGRADE PROTECTED SIDE OF LEVEE TO THE ALLOWABLE STRUCTURAL EXCAVATION
LIMITS (2'-4"), TO ALLOW FOR ACCESS ROAD,
W/L STA.126+00 TO W/L STA. 97+52

FLOOD SIDE NOTE: PROTECTED SIDE DRAWINGS IN THIS FOLIO HAVE BEEN REDUCED ONE CONSTRUCTION R/W -HALF THE ORIGINAL SCALE SAFETY FENCE - EXISTING SHEET PILE EROSION CONTROL BALES LEGEND SHEET PILE TO BE CAPPED SYMBOL SHEET PILE LEFT UNCAPPED 35' CONSTRUCTION R/W --- CONSTRUCTION R/W U.S. ARMY ENGINEER DISTRICT, NEW ORLEANS UTILITY EXCAVATED MATERIAL MUST BE HAULED IN ACCORDANCE WITH C2C OF THE SPECIFICATIONS AND STORED FOR ----- CONSTR. R/W, SAFETY FENCE, EROSION CONTROL STA.116+00 TO STA.98+00 SHOWN. OTHERS AREAS SIMILAR. REUSE IN ACCORDANCE WITH SPECIAL CLAUSE ----- CONSTR. R/W AND SAFETY FENCE "OFFSITE STORAGE". ACCESS AND STORAGE DETAILS LAKE PONTCHARTRAIN, LA. AND VICINITY HIGH LEVEL PLAN

17TH STREET CANAL

EXCAVATION AND FLOODWALL PROTECTION
CAPPING OF FLOODWALLS
EAST SIDE LEVEE IMPROVEMENTS STA.126+03 TO STA.97+52 SCALE I"= 10'-0" ACCESS NOT SHOWN FOR CLARITY SCALE: |" = 100" PLAN-I AND GENERAL NOTES \oplus SCALE: I" = 10" DESIGNED BY: F.S. DRAWN BY: P.M.R. C·A·D CHECKED BY: M.L.S. SUBMITTED BY: W. B. CONWAY MODJESKI & MASTERS DESIGN ENGINEER

21 MAY 1993

MODJESKI & MASTERS Inc. NEW ORLEANS, LOUISIANA

PLOT DATE: APR 1993

H-4-40208

DWG. 2 OF 16

CORPS OF ENGINEERS

NEW ORLEANS, LOUISIANA

NOV. 1992 | 1200

DACW29-93-B-0025

CADD FILE: 40208X02.DGN

RJG

Safety is a Part of Your Contract LAKE PONTCHARTRAIN -USCE MON. 14 226' WEST OF W/L STA.5+11.80 OR 247' NORTH OF N.W. CORNER OF HAMMOND HWY. BRIDGE NORTH ABUTMENT. EL.= 8.77 N.G.V.D. \triangle BEGIN EXIST. SHEET PILE W/L STA.7+03.78 -BEGIN CONCRETE CAP W/L STA.7+00.00 FLOW W/L 8+49--CONSTRUCTION R/W -CONSTRUCTION R/W 17TH STREET CANAL END EXIST. SHEET PILE , W/L STA. 8+48.45-P.I. W/L STA.0+72.69 P.I. W/L STA.21+27.62 -FLOOD SIDE REO'D SAFETY FENCE WITH EROSION CONTROL (PROTECTED SIDE ONLY, SEE SECTION BELOW) —END CONCRETE CAP W/L STA.0+37.73 END CONCRETE CAP W/L STA.9+25.80--CONSTRUCTION R/W PROTECTED SIDE REO'D SAFETY FENCE WITH EROSION CONTROL (PROTECTED SIDE ONLY, SEE SECTION BELOW) -END EXIST. SHEET PILE W/L STA.0+00.00 STORAGE AREA -LIMIT OF WORK, 20' EAST OF W/L STA.0+00.00 - C EXIST. & NEW FLOODWALL (SEE DETAIL, REO'D SAFETY FENCE - ACCESS SITE (SEE DWG. NOS.15 & 16 FOR DETAILS) -REO'D SAFETY FENCE END R/W AT LAKE MARINA DRIVE PLAN LEGEND SCALE I" SHEET PILE TO BE CAPPED LAKE MARINA DRIVE SHEET PILE LEFT UNCAPPED SOUTH BOUND LANE --- CONSTRUCTION R/W ----- CONSTR. R/W, SAFETY FENCE, EROSION CONTROL DEGRADE PROTECTED SIDE OF LEVEE ----- CONSTR. R/W AND SAFETY FENCE TO THE ALLOWABLE STRUCTURAL EXCAVATION LIMITS (2'-4"), TO ALLOW FOR ACCESS ROAD, STORAGE AREA STA.2+80 TO STA.1+30 (APPROX. 250 C.Y.) MATERIAL TO BE REUSED. CONTRACTOR TO PROVIDE SCALE: I'' = 100' HAMMOND HWY. TO STA. I+OO. EROSION CONTROL DRAINAGE THROUGH MATERIAL -STORAGE AREA FOR \triangle AT STA.2+05 SAFETY BALES RIP-RAP DURING CAP CONSTRUCTION. SCALE: 1" = 10" -STORAGE AREA FOR EXCAVATION MATERIAL - DEPTH OF 6 INCHES STA.40+13 TO STA.10+86 CONSTRUCTION R/W APPROX. 430 C.Y.) MATERIAL SAFETY-FENCE SAFETY FENCE 25' CONSTR. R/W HAMMOND HWY. EROSION CONTROL BALES-EXISTING SHEET PILE CONSTRUCTION R/W TO STA.3+00 ADDED RIGHT-OF-WAY, CHANGED R/W LIMITS AMEND. *2 DESCRIPTION - EXISTING SHEET PILE 50' CONSTRUCTION R/W U.S. ARMY ENGINEER DISTRICT, NEW ORLEANS STA.3+00 TO STA.1+08+/-CORPS OF ENGINEERS
NEW ORLEANS, LOUISIANA RETAINING WALL 27'+/- EAST OF SHEET PILE FROM STA.7+04 TO STA.3+35 NOT SHOWN FOR CLARITY. EXCAVATED MATERIAL IN EXCESS OF STORAGE IN THIS REACH TO BE HAULED IN ACCORDANCE WITH SECTION C2C OF THE SPECIFICATIONS AND STORED FOR REUSE IN ACCORDANCE WITH THE SPECIAL CLAUSE "OFFSITE STORAGE". MODJESKI & MASTERS Inc. NEW ORLEANS, LOUISIANA LAKE PONTCHARTRAIN, LA. AND VICINITY HIGH LEVEL PLAN


17TH STREET CANAL


EXCAVATION AND FLOODWALL PROTECTION
CAPPING OF FLOODWALLS
EAST SIDE LEVEE IMPROVEMENTS MATERIAL EXCAVATED FROM BELOW EL.2.0 IS TO BE HAULED IN ACCESS AND STORAGE DETAILS ACCESS AND STORAGE DETAILS PLAN-4 HAMMOND HWY. TO STA.0+00 SCALE I" = 10'-0" STA.40+13 TO HAMMOND HIGHWAY SCALE I" = 10'-0" ACCESS NOT SHOWN ON PLAN FOR CLARITY STORAGE ON LEVEE NOT SHOWN ON PLAN FOR CLARITY.


SUBMITTED BY:
W. B. CONWAY
MODJESKI & MASTERS I


C·A·D

PLOT DATE: APR 1993 DESIGNED BY: F.S. ov. 1992 1200 DRAWN BY: P.M.R.
CHECKED BY: M.L.S. H-4-40208 ADD FILE: 40208X05.DGN OLICITATION NO DWG. 5 OF 16 DACW29-93-B-0025

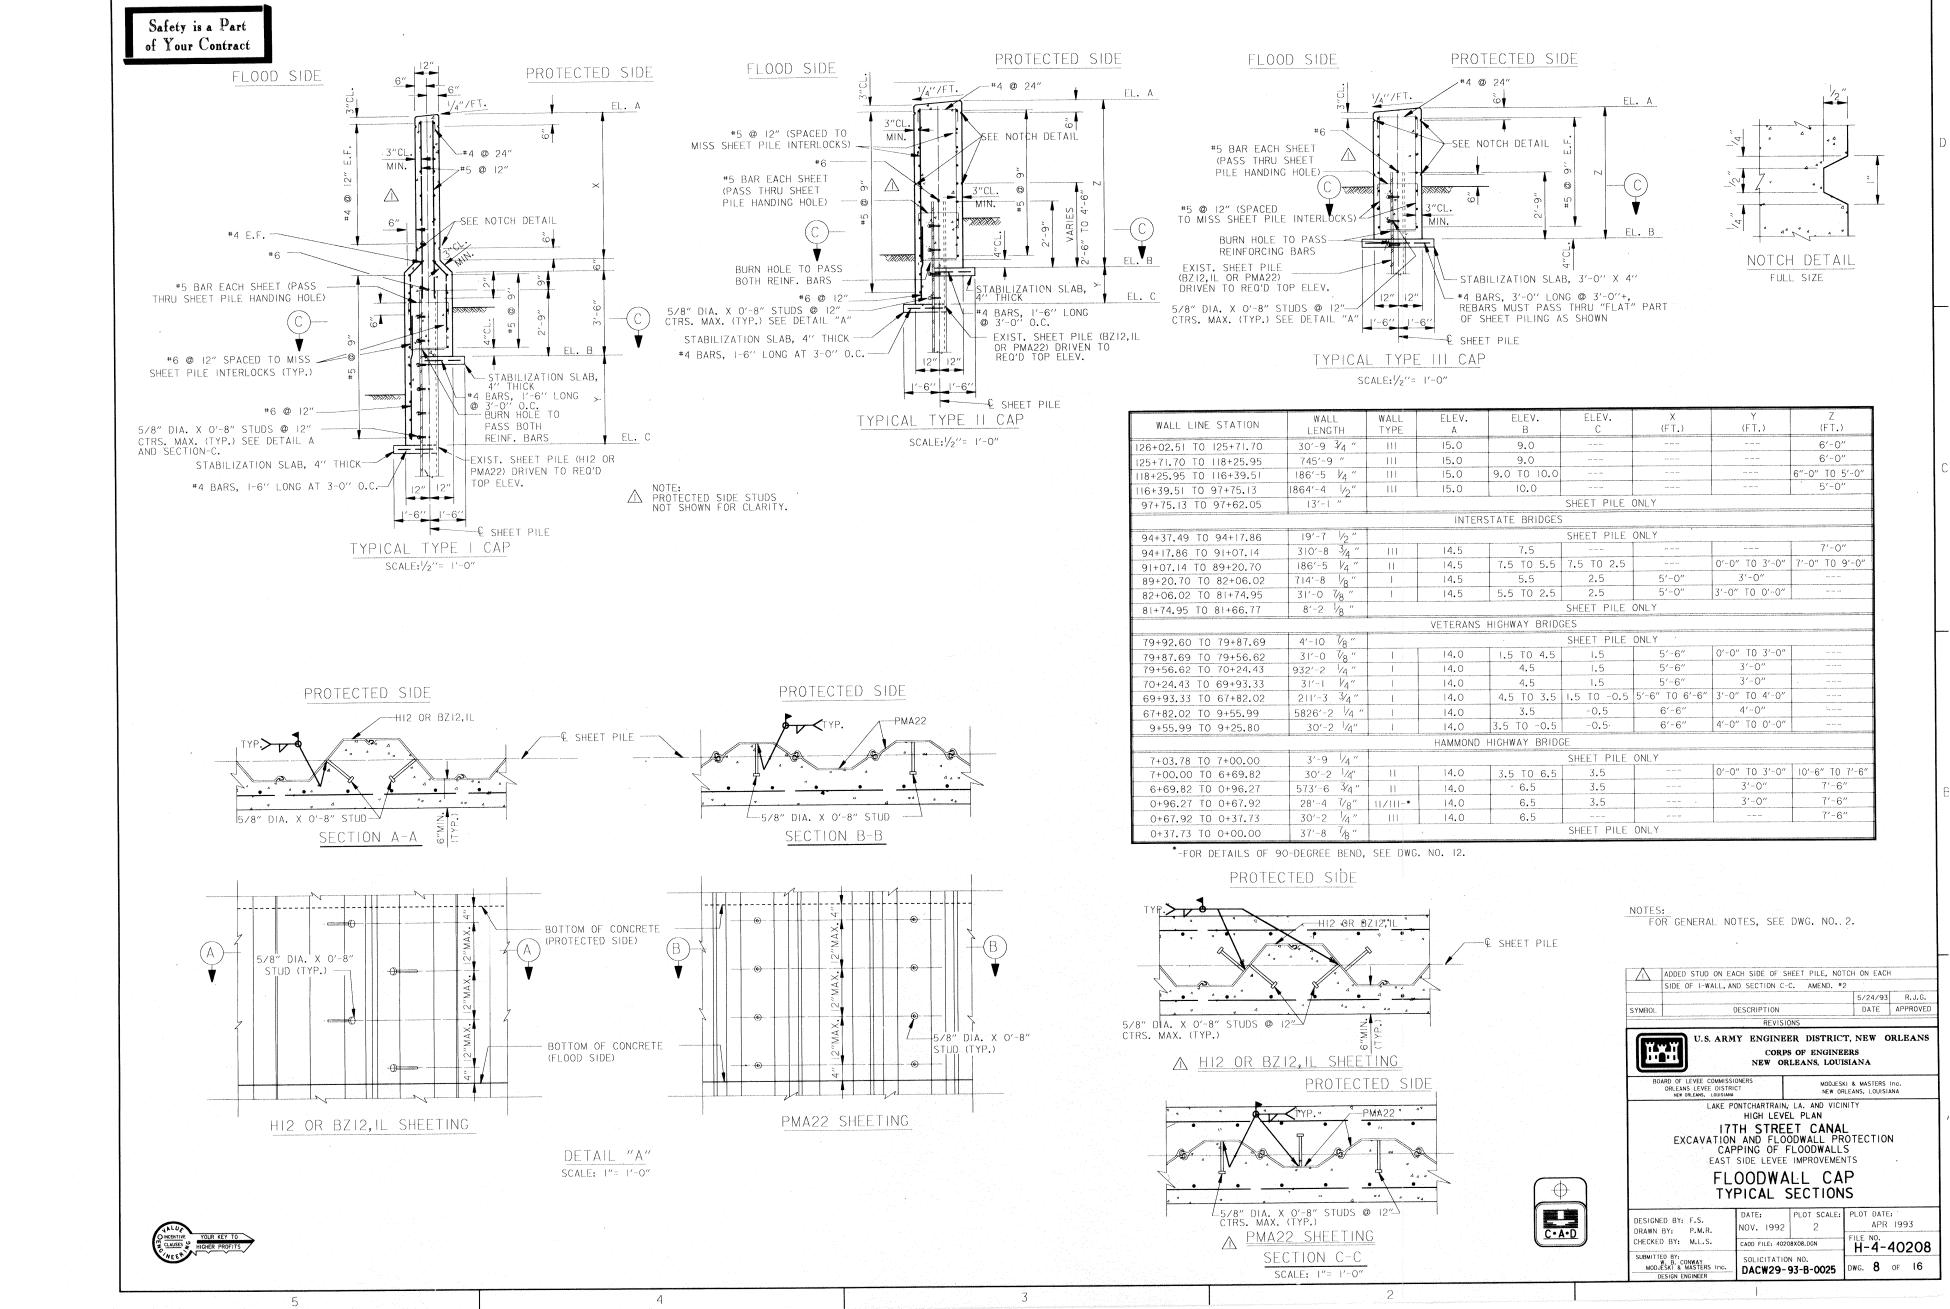


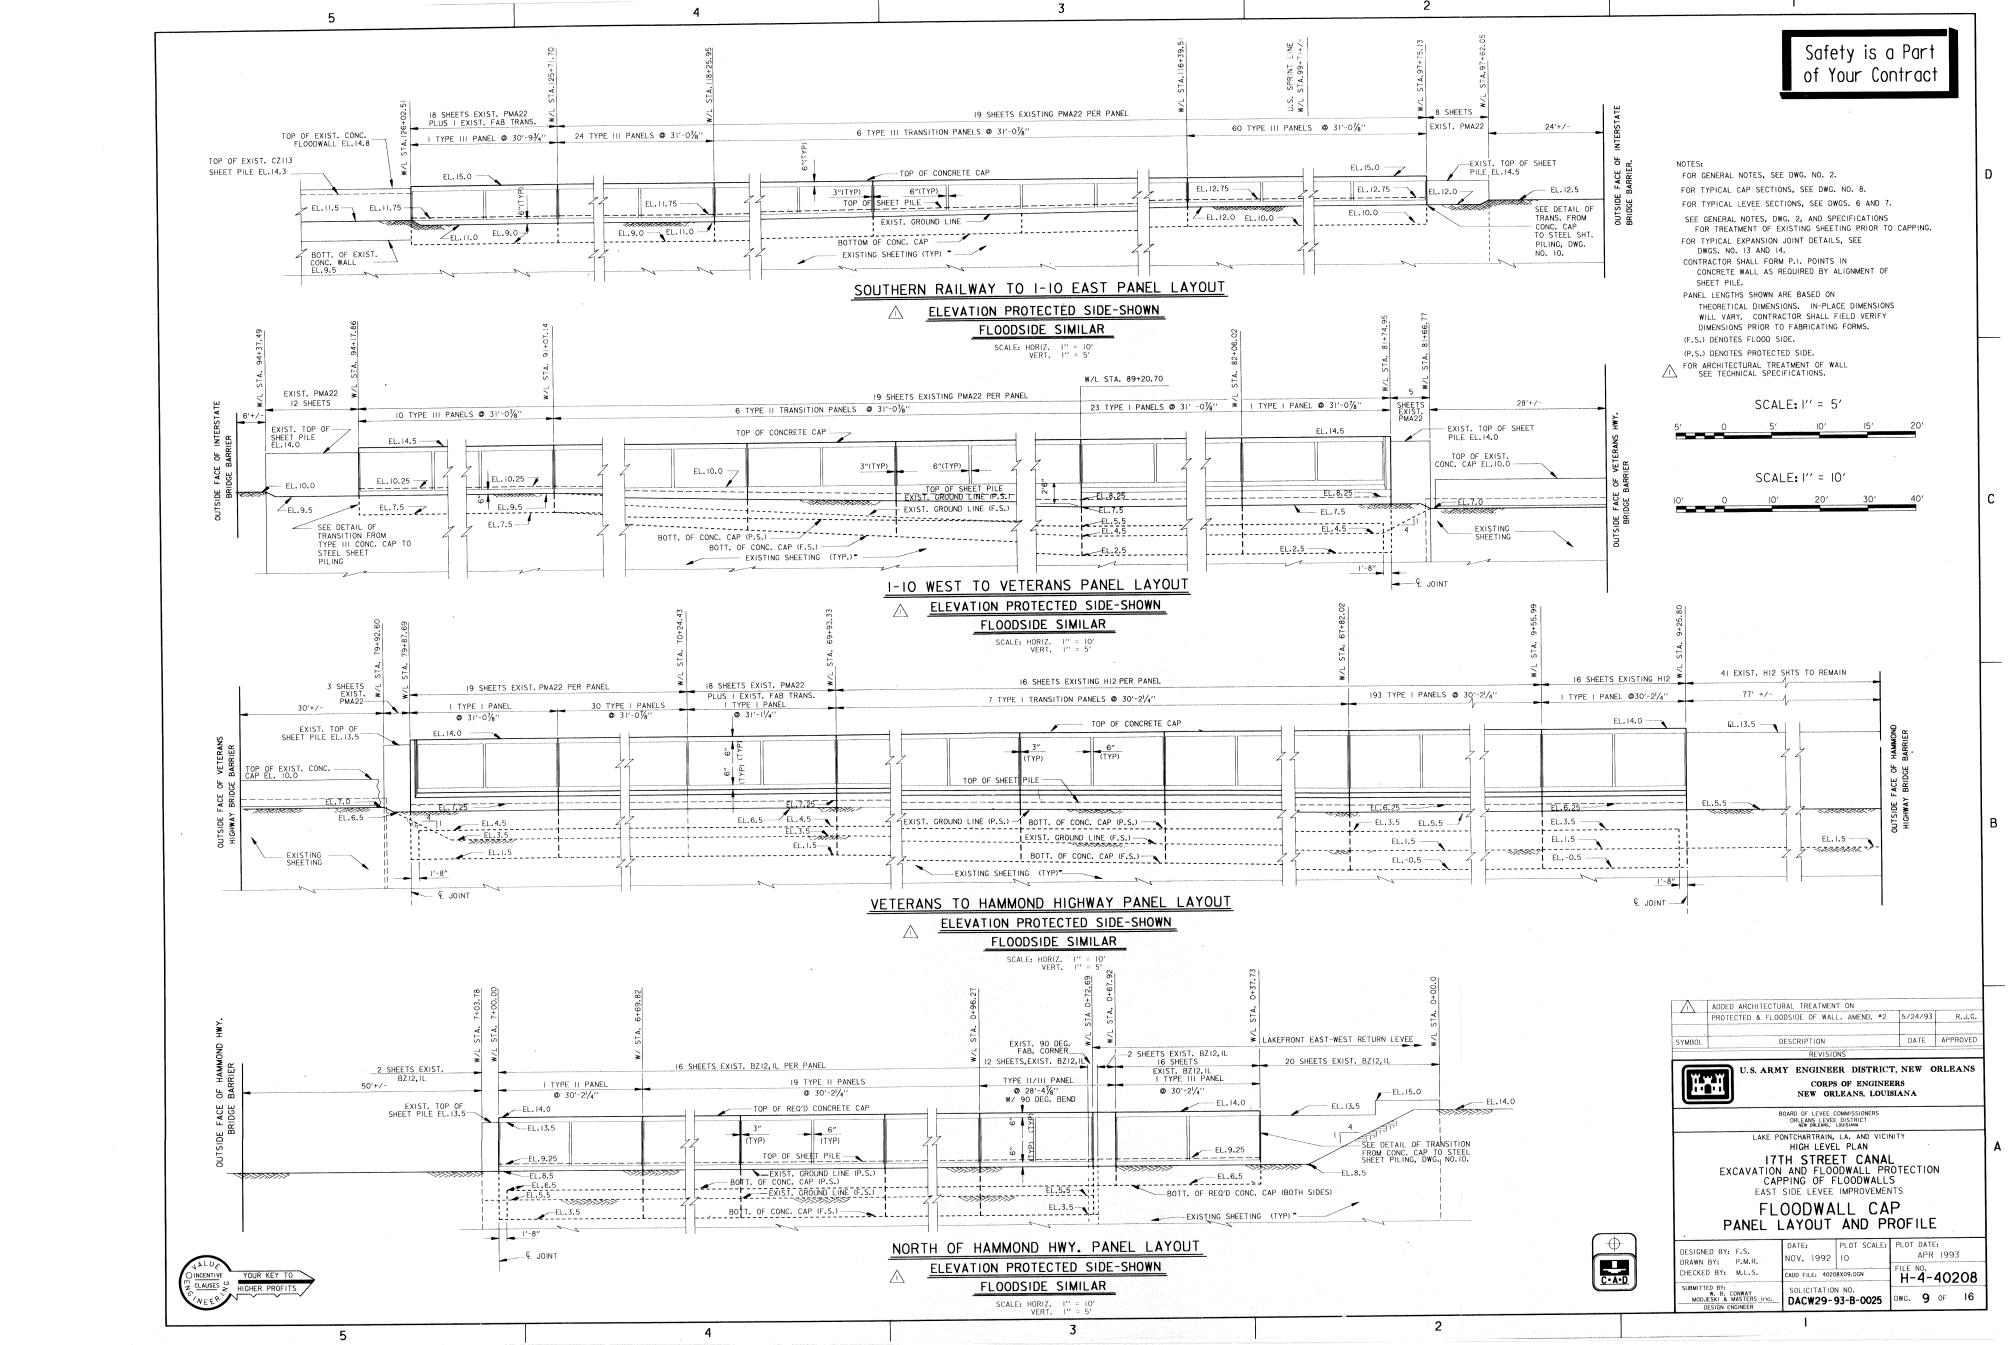

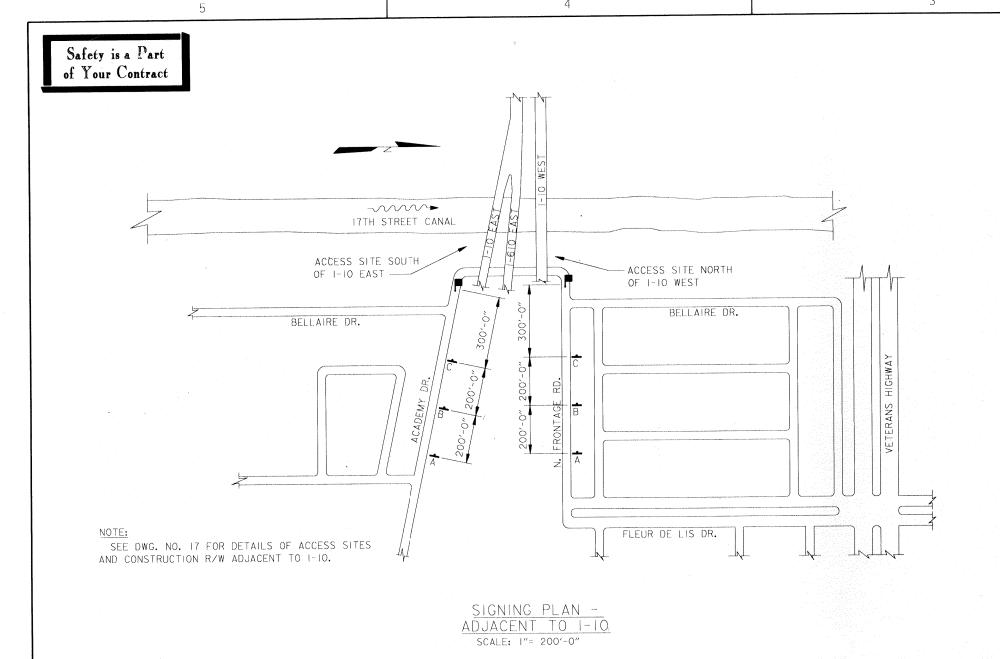


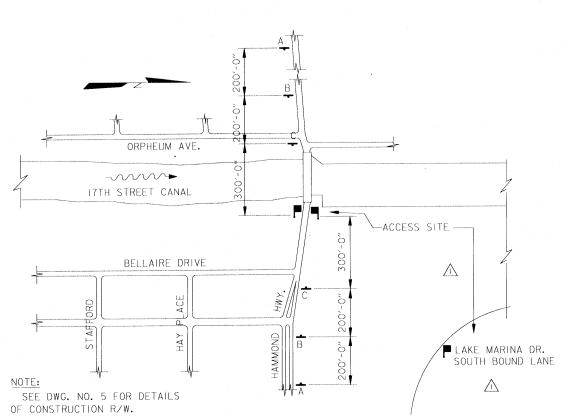

<u>signing plan -</u> During operations north of Hammond Hwy. SCALE: I"= 200'-0"

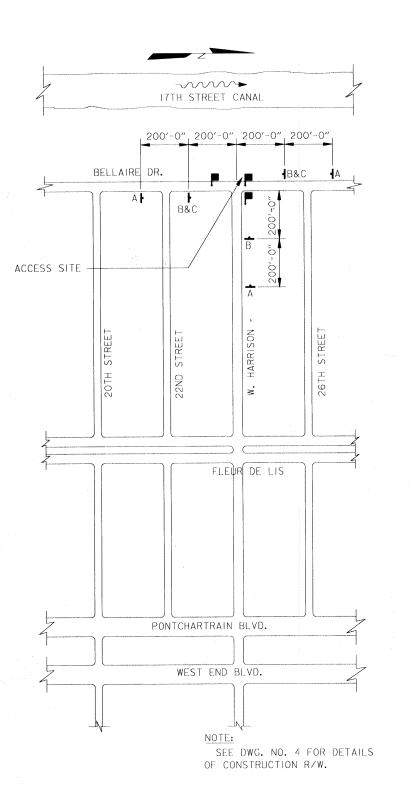

SIGNING PLAN -WEST HARRISON AVENUE SCALE: I"= 200'-0"

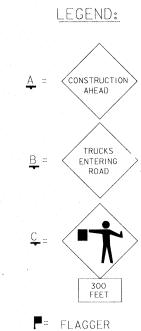

NOTES:

FOR GENERAL NOTES, SEE DWG. NO. 2.
ALL ADVANCE FLAGGER SIGNS SHALL BE PROMPTLY REMOVED OR COVERED WHENEVER FLAGGERS ARE NOT AT THEIR STATIONS.
FLAGGERS SHALL BE POSTED WHENEVER THERE IS TRUCK ACTIVITY AT THE ACCESS SITE.

| | AMEND. #2 | 5/24/93 | R.J. |
|---------|-------------|---------|--------|
| SYMBOL. | DESCRIPTION | DATE | APPROV |
| | REVISIONS | | |

LAKE PONTCHARTRAIN, LA. AND VICINITY
HIGH LEVEL PLAN

I7TH STREET CANAL
EXCAVATION AND FLOODWALL PROTECTION
CAPPING OF FLOODWALLS
EAST SIDE LEVEE IMPROVEMENTS

ACCESS SITES AND TRAFFIC CONTROL-I



PLOT DATE: APR 1993 DESIGNED BY: F.S. DRAWN BY: P.M.R. CHECKED BY: M.L.S. NOV. 1992 2400 H-4-40208 SUBMITTED BY:
W. B. CONWAY
MODJESKI & MASTERS Inc.
DESIGN ENGINEER SOLICITATION NO.
DACW29-93-B-0025 DWG. 15 OF 16

