

CONSULTANTS:



SEAL:

PROJECT INFORMATION:  
**LOW VOLTAGE  
SWITCHBOARDS  
REPLACEMENT**

**GREENVILLE, NC  
TRANSMITTING STATION  
SITE B**

**Task Order 14  
100% CONTRACT DRAWINGS**

KEYPLAN:

NO.	DATE	DESCRIPTION
0000000	-	
0000000	-	
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0000000	-	
0000000	-	

DRAWN BY:	SD	DATE:	10/25/07
CHECKED BY:	GR	DATE:	10/25/07
PROJECT NUMBER:	32217014		
DRAWING SCALE:	1" = 1'		
SHEET TITLE:			

**EXISTING LOW VOLTAGE  
SWITCHBOARD ELEVATION**

SHEET NUMBER: **4** OF: **9**


DRAWING NUMBER:  
**ED-601**

**GENERAL NOTES**

- SEE E-402 FOR ELECTRICAL ABBREVIATIONS, SYMBOLS AND ADDITIONAL INFORMATION.
- SEE DWG E-5022, EXISTING PARTIAL SINGLE LINE DIAGRAM FOR ADDITIONAL CIRCUIT BREAKER INFORMATION.

**DEMOLITION NOTES**

- EXISTING CABLE TO REMAIN IN SWITCHBOARDS FOR CONNECTION TO NEW BREAKERS.
- REMOVE EXISTING BUSDUCT FOR PARTS 1 & 2, AS MUCH AS POSSIBLE.
- PROVIDE TEMPORARY SUPPORT OF OVERHEAD BUSDUCT DURING CHANGE OUT OF SWITCHBOARDS.

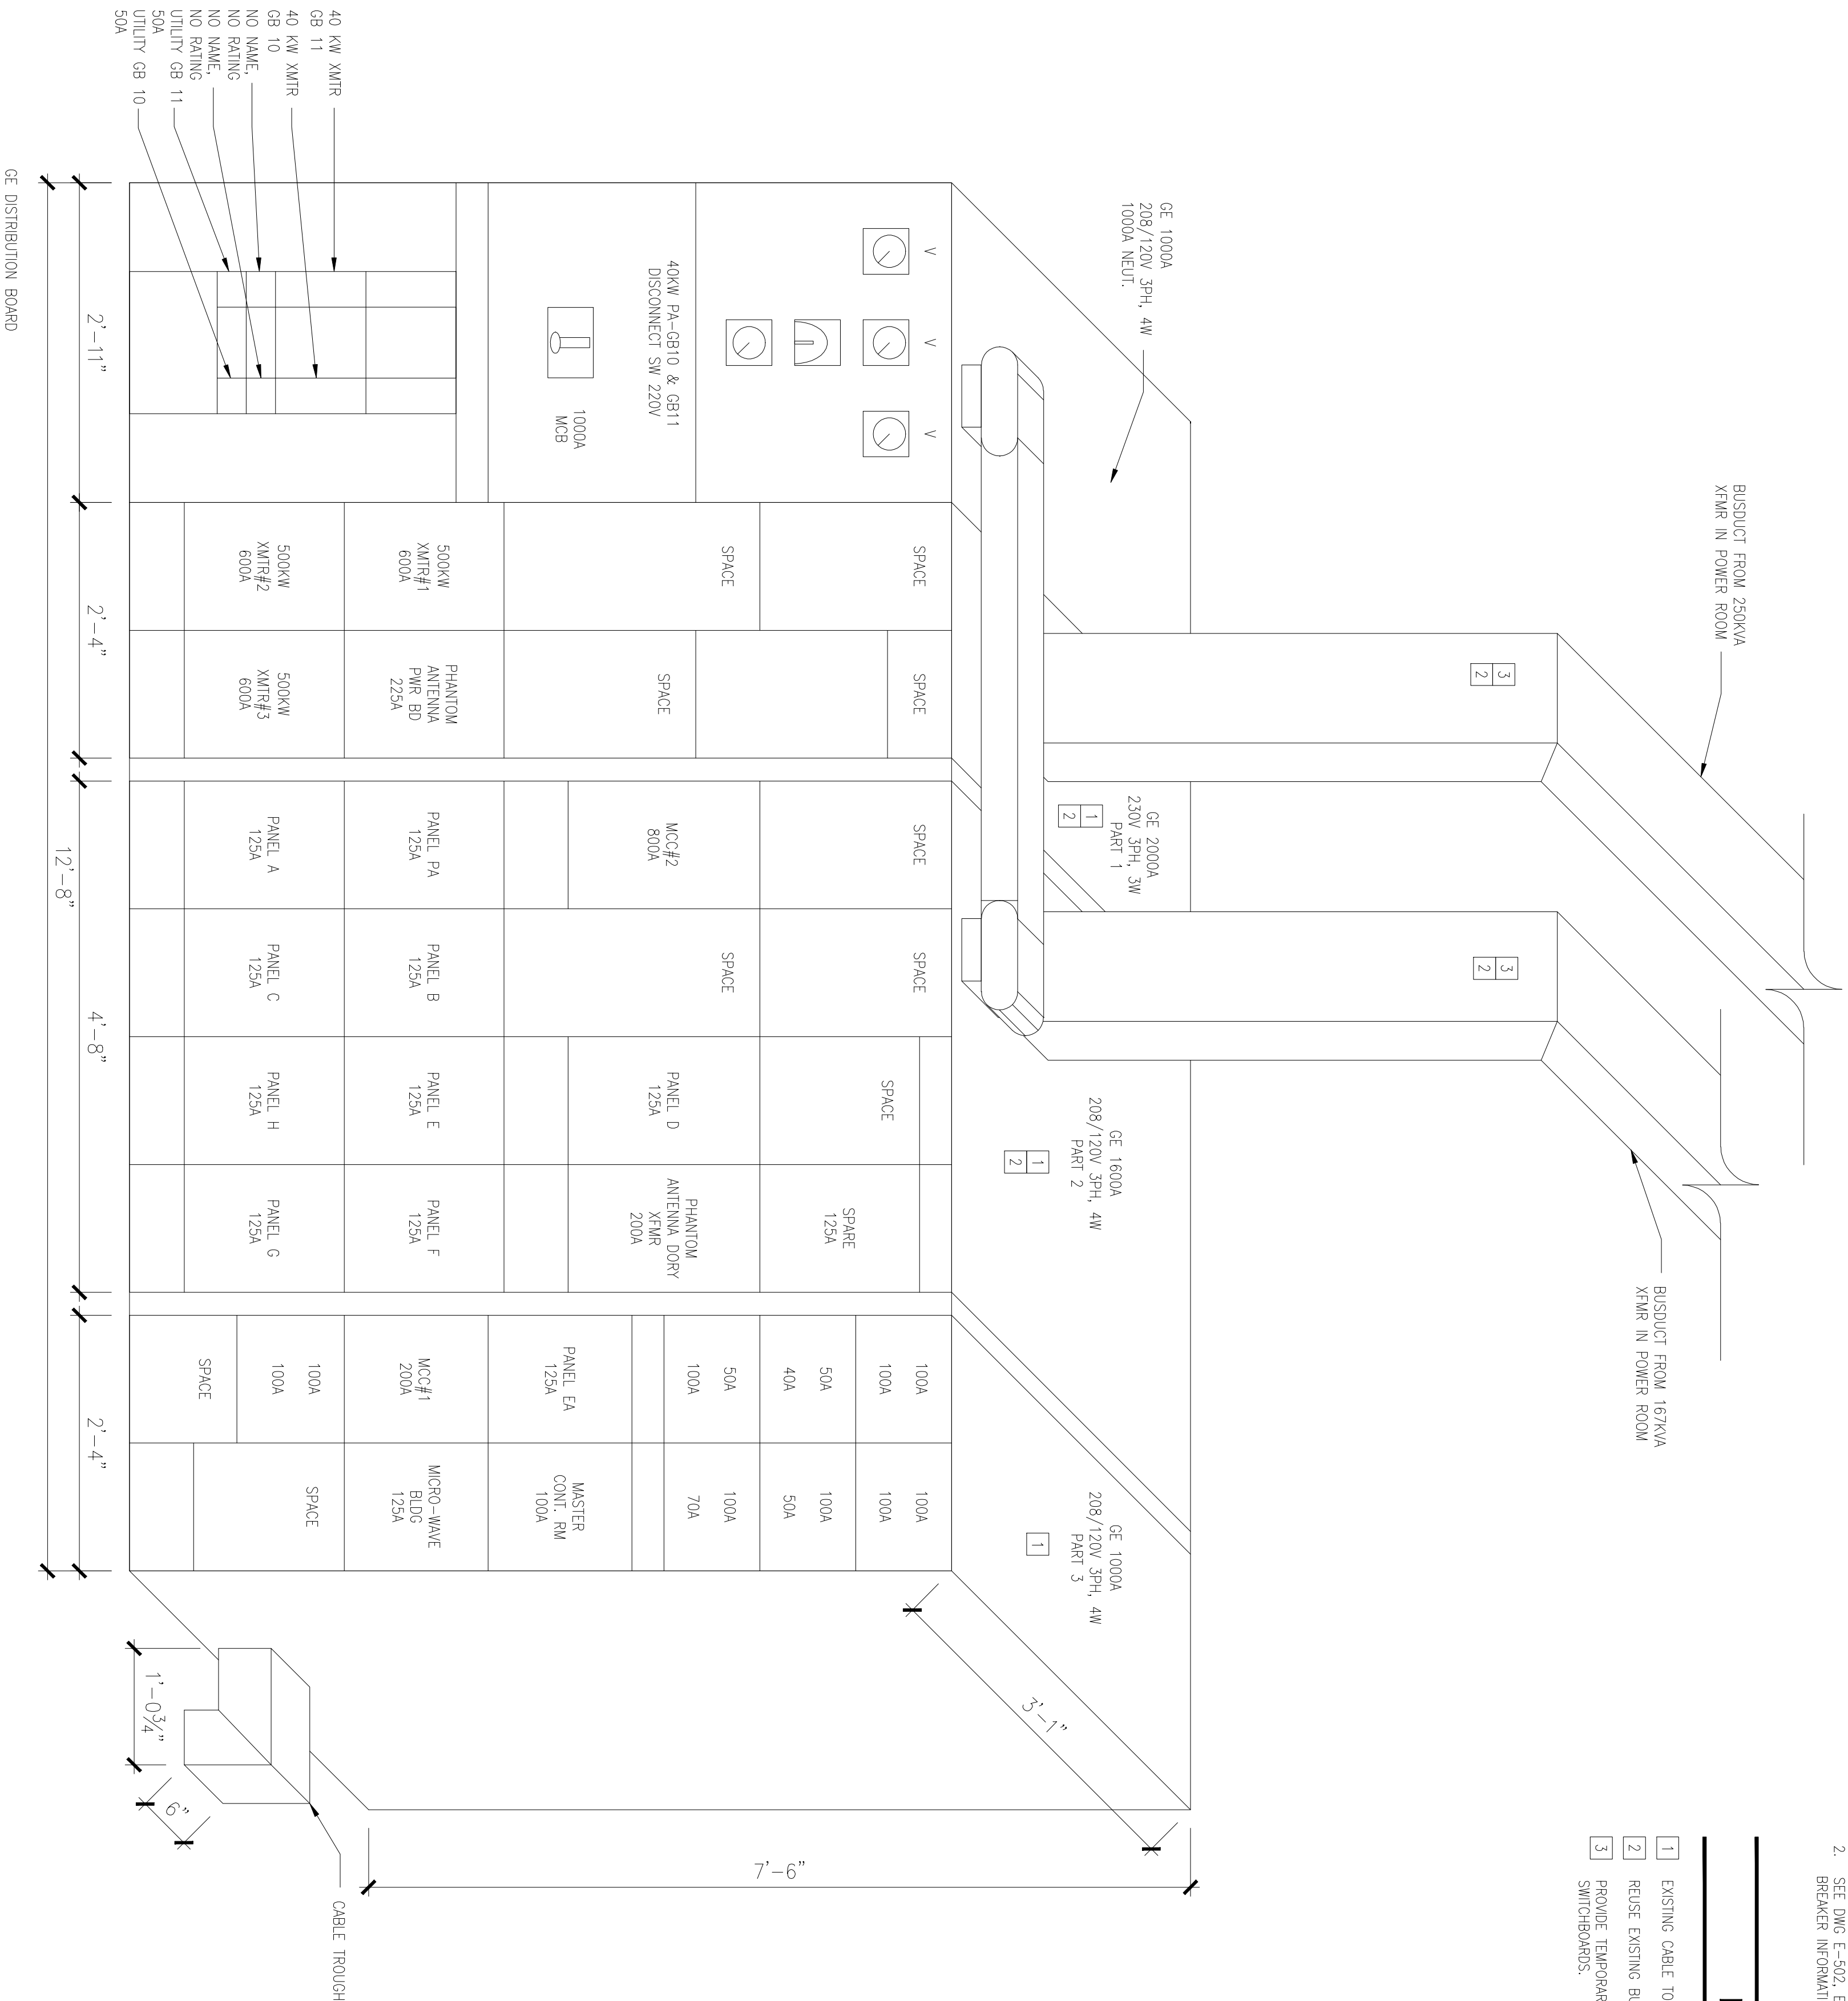

**1 EXISTING LOW VOLTAGE SWITCHBOARD ELEVATION-DEMO**

**ED-601 1" = 1'**