

CONSULTANTS:



Engineering Services  
2020 K Street, NW, Ste 200  
Washington, DC 20006

SEAL:

PROJECT INFORMATION:

LOW VOLTAGE  
SWITCHBOARDS  
REPLACEMENT

GREENVILLE, NC  
TRANSMITTING STATION  
SITE B

Task Order 14  
100% CONTRACT DRAWINGS

KEYPLAN:

NO.	DATE	DESCRIPTION
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DRAWN BY:	SD	DATE:	10/25/07
CHECKED BY:	GR	DATE:	10/25/07

PROJECT NUMBER: 32217014

DRAWING SCALE: 1/4" = 1'-0"

SHEET TITLE:

PARTIAL FLOOR PLAN  
NEW WORK

SHEET NUMBER: 5 OF: 9

DRAWING NUMBER:


E-101

GENERAL NOTES

- SEE E-002 FOR ELECTRICAL ABBREVIATIONS, SYMBOLS AND ADDITIONAL INFORMATION.
- WHERE CONDUCTORS REQUIRE SPLICES:
  - USE BURRY HYLM, LONG BARBED BUTT SPLICE COMPRESSION LUG TYPE VS. OR APPROVED EQUAL.
  - WAPY BARREL LUG WITH SCOTCH C130 INSULATING TAPE OR APPROVED EQUAL.
  - FINISH WIRE WITH SCOTCH 88 TAPE OR OR APPROVED EQUAL.
  - INSULATOR TYPE LUGS ARE NOT ACCEPTABLE.
- WHERE CONDUCTORS PASS VERTICALLY THROUGH A SWITCHBOARD NOT INTENDED FOR TERMINATION IN THAT SECTION SHALL BE ISOLATED BY AN APPROVED BARRIER.

CODED NOTES

- INSTALL NEW LOW VOLTAGE SWITCHBOARDS PARTS 1, 2, & 3 IN SAME LOCATIONS AS EXISTING.
- NEW LOW VOLTAGE SWITCHBOARDS SHALL MATCH EXISTING FOOTPRINT OF EXISTING CONDUTORS IN SOGB.
- PROVIDE INLINE CABLE SPLICES AS REQUIRED FOR SUFFICIENT CABLE LENGTHS TO NEW BREAKERS REPLACE EXISTING 1600AMPS AND 2000AMPS BUSDUCT FROM TRANSFORMERS TO SWITCHBOARDS PARTS 1 AND 2. SEE SPEC. SECTION 012000.
- ADD ALTERNATE: REPLACE EXISTING 1600AMPS AND 2000AMPS BUSDUCT FROM TRANSFORMERS TO SWITCHBOARDS PARTS 1 AND 2. SEE SPEC. SECTION 012000.

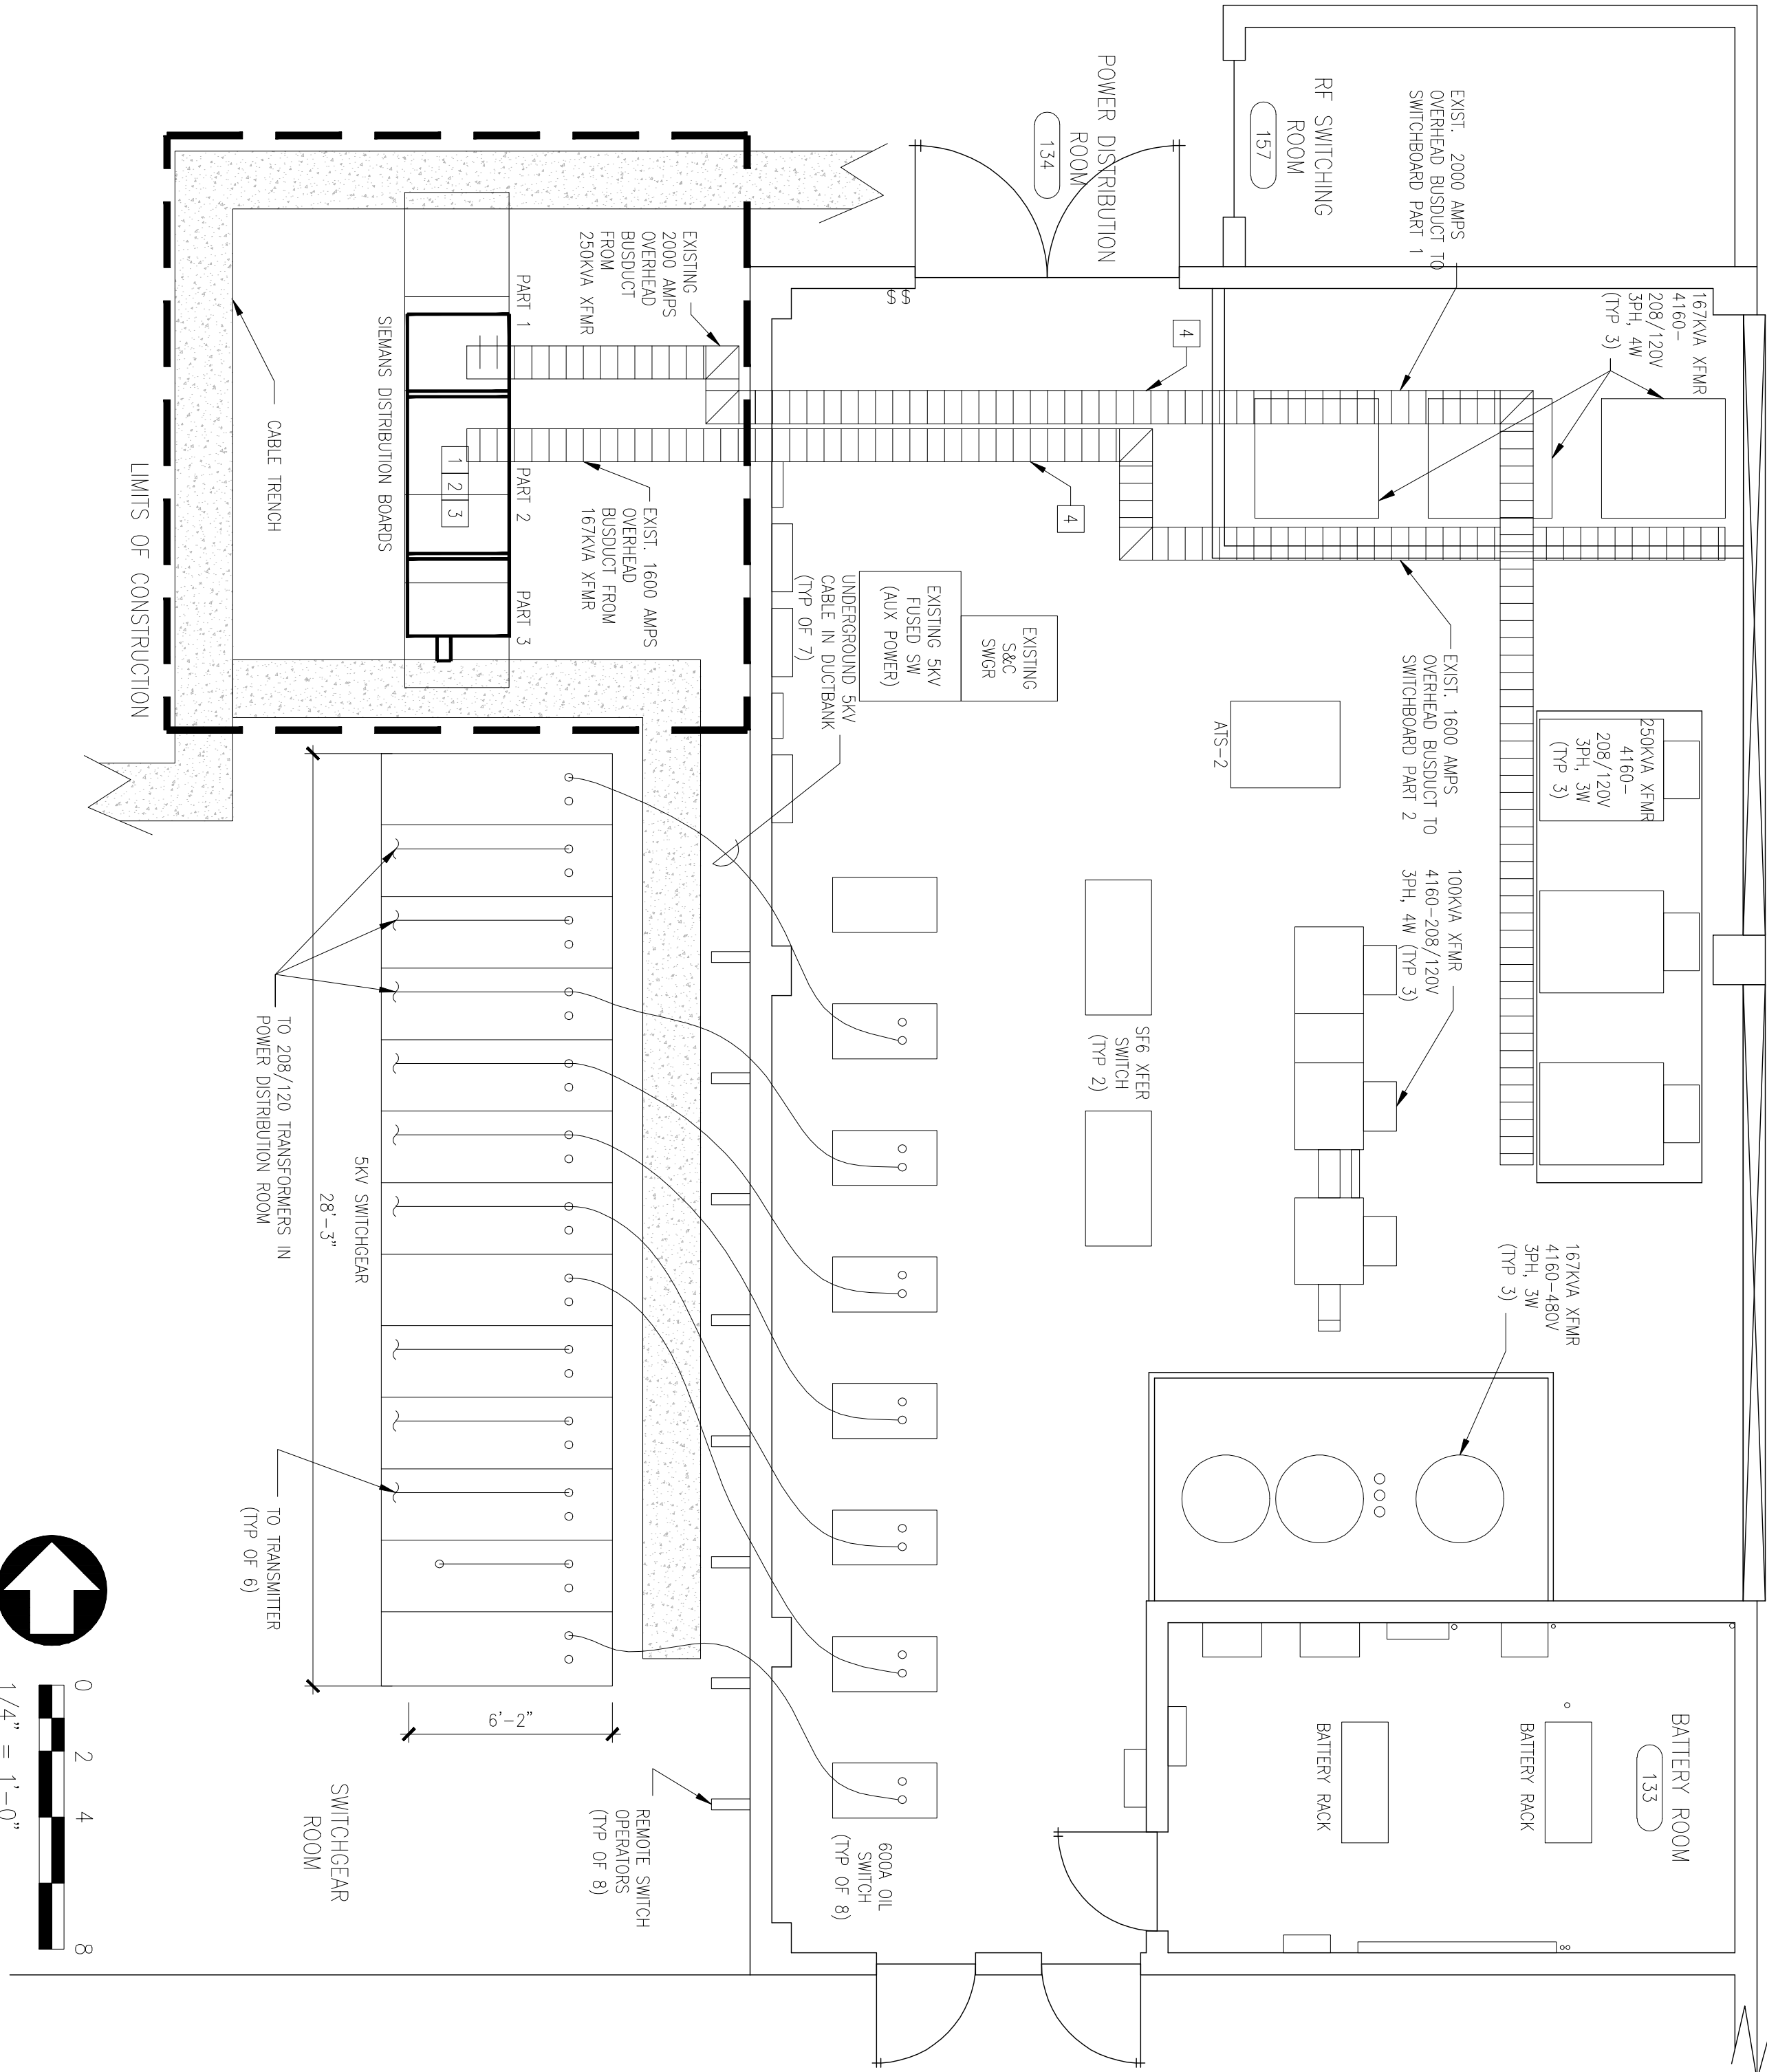

1  
PARTIAL FLOOR PLAN - NEW WORK  
E-101 1/4" = 1'-0"

